Revision to the approved 14 Residential Lofts and Villas Renovation at 18, 22a and 22b Battery Road St. George's (PHASE 1 & 2) - were adding two units to create a 16-Unit Development.

See new unit matrix Pg. A16

Index of Drawings A-1: Cover

Index of Drawings

Property Stats

Lot size: 6.52 acres / 284037.28 sq.ft

Zone: Residential 1 BOCA user Group: R3

Units Per Acre: 6.52 (entitled 130 units)

Existing building area- condos: $19,352 \times 2 = 38704 \text{ sqft (total)}$

Existing building area: 1,768 sq.ft Sal Army 668 sq.ft 20 battery Cottage,

1,077 sq.ft south ancil/storage.,

2,807 cottage large,

426 sq.ft small cottage,

1187 sqft rectangular cottage, $1076 \times 2 = 2,152$ sq.ft 2 storey house north

Nursery? 1200

Storage in circle? 800

Total Existing building area:= 30,361 sqft

(site coverage) 10.69%

28 parking bays (cars)

Tank(s) size: N/A (BHC supplied infrustructure) Cesspit: proposed - $12' \times 24' \times 8'$ (2,304 cubic ft.)

Hard surfacing: Existing: 86,900 sqft

(roads, sidewalks, solid surfaces play areas) Proposed additional: -4,808 sqft (removed asphalt between Phase I and Phase II)

Total 82,092 sqft 28% hardsurface

Roof Area: 30,361 sq.ft

(Unchanged)

A-2: Location and General notes A-3: Survey /Civil Details

A-4: Site Plan + Landscaping

A-5: Demo Floor Plan

A-7: Floor Plan

A-9: Elevations



A-29 Phase II Door and window Schedule A-30 Phase II Door and window Schedule

A-32 Kitchen Plans/Elevations



A-13: Phase 1 (Building 22 a & b) Building Sections and Details

Section

A-15 Phase 1 (Building 22 a & b) Site Cross Section

A-16 Phase II (Building 18) Building Plan unit Matrix

A-17 Phase II (Building 18) Building Demo and

Reno Plan

A-18 Phase II (Building 18) Building

Dimensioned Plan 1st Flr

A-19 Phase II (Building 18) Building

Dimensioned Plan 2nd Flr

A-20 Phase II (Building 18) Building Roof

Framing Plan (lower)

A-21 Phase II (Building 18) Building Roof

Framing Plan (main)

A-22 Phase II (Building 18) Building Sections

A-23 Phase II (Building 18) Building Sections and Details

A-24 Phase II (Building 18) Building Sections

and Details A-25 Phase II (Building 18) Electrical 1st floor

A-26 Phase II (Building 18) Electrical 2nd floor

A-27 Phase II (Building 18) Plumbing 1st &


2nd floor (West end)





4/15/2024

SCALE:

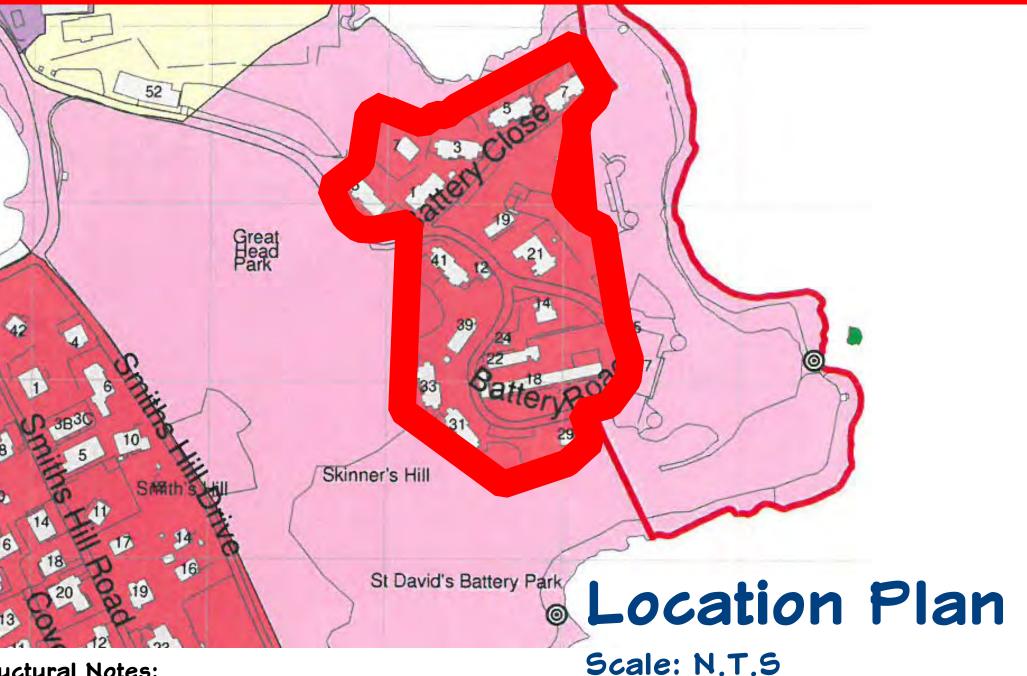





110,760.63 sq.ft

Site Plan Area

© 1.145 Ha.

lans Note

DATE:

4/15/2024

SCALE:

SHEET:

Structural Notes:

1. Carefully excavate near existing bearing wall and foundations: 2. All steel reinforcing shall be galvanized, of a minimum grade 60 ksi steel. All tie wire shall be galvanized.

3. All concrete shall be a minimum of 3000 psi at 28 days

4. Pour concrete slabs, beams and columns in continuous between supports to avoid cold joints

5. Concrete shall be thoroughly compacted by the use of a vibrator.

6. Minimum coverage for reinforcing steel shall be as follows: Cast against earth-3": Exterior or in Water tanks: 1/1/2": All other places - 1"

7. Lap reinforcing steel in concrete and masonry per table below.

T6 bars 12" T16 Bars 32"

T8 bars 16" T20 Bars 40"

T10 bars 20" T25 Bars 60"

T12 bars 24" Mesh One Square

8. For beams and slabs use continuous bars over spans. Lap bars over supports only except for cantilever steel.

9. Lintel shall be placed over all openings in walls. Lintels shall bear a minimum pf 8" onto blockwalls either side. Reinforcing is to be extended 6" over the support. Cells beneath bearing shall be closed/solid filled down to slab level Lintels shall bear on stone walls a minimum of 12" each side.

10. Unidentified lintels on drawings (new construction/alterations) shall be cast-in-place reinforced concrete and sized as follows:

Spans from 0' to 4' Width of wall x 8" deep reinforced with 3T12 bottom

Spans from 0' to 6' Width of wall x 10" deep reinforced with 2T12 bottom

Per section 8.6.2 Bearing: Lintels shall bear a minimum of 8" omto masonry walls either side. For openings of 6' or greater the the cells either side of the opening shall be solid filled to the floor below.

11. Block work shall be a minimum of 1900 psi compressive strength. Masonry shall be laid in running bond contraction Fill all cells below grade, at corners, either side of windows/doors opening and cells that are reinforced. All cell shall be cleaned out prior to filling. Concrete fill for block work shall be a minimum of 2000 psi @ 28 days. Block work to be filled in maximum 4' high lifts. Concrete fill shall stopped at 2" from the top of the block cell to allow the next lift to key together.

12. Do not backfill against retaining wall until walls are completed and cured. For subgrade walls place backfill is encountered, notify and consult with the designer.

13. Concrete belt course measuring width of wall X minimum 8" deep shall be poured at roof level, reinforced with a minimum of 2T12 bars. The belt shall be placed over all exterior and interior bearing walls. At corners and intersections of walls bars shall lap 36".


14. Contractor shall install all necessary temporary propping and shoring to the existing structure to adequately support during demolition / excavation / renewal operations. All temporary shoring shall remain in place until all loadbearing members are in place and cured sufficiently to support loads. Contractor shall ensure all existing structure is not damaged while carrying out with new construction.

15. Connect timber wall plates with 1/2" dia. x 10 long galv. J bolts with 2" hooks cast into concrete beams / belts at 4'-0" C / C and 4" from ends of members. Rafters deep wolmanised pitch pine bolted to concrete belt. Rafters to be connected to wall plate with Simpson Strong Tie Type H2.5 fully nailed galvanized hurricane clips each side. Rafter to have 1" deep birdsmouth connection at wall plate.

16. Timber framing shall be a minimum of No. 2 grade Southern Yellow Pine (Pitched) unless noted elsewhere. All nails, bolts, washers, hurricane clips and anchors shall be galvanized. All exterior timber and timber in contact with concrete, blockwork or stone is to be wolmanised (Pressure Treated) to a minimum standard of 0.25 Ibs/ cubic ft. CCA. each side. Rafter to have 1" deep birdsmouth connection at wall plate.

17. Metal decking shall be placed and propped at maximum 5' centers. Propping to be extended down at grade level with loads spread such as not to damage lower structure. Decking shall be galvanized to a minimum grade of G90. Decking shall bear a minimum of 3" onto blockwalls and steel beams. Decking shall be welded to beams at 12" C/C.

18. At the End of each day, Contractor shall secure site to take safety precaution for neighboring community and tradesmen alike.

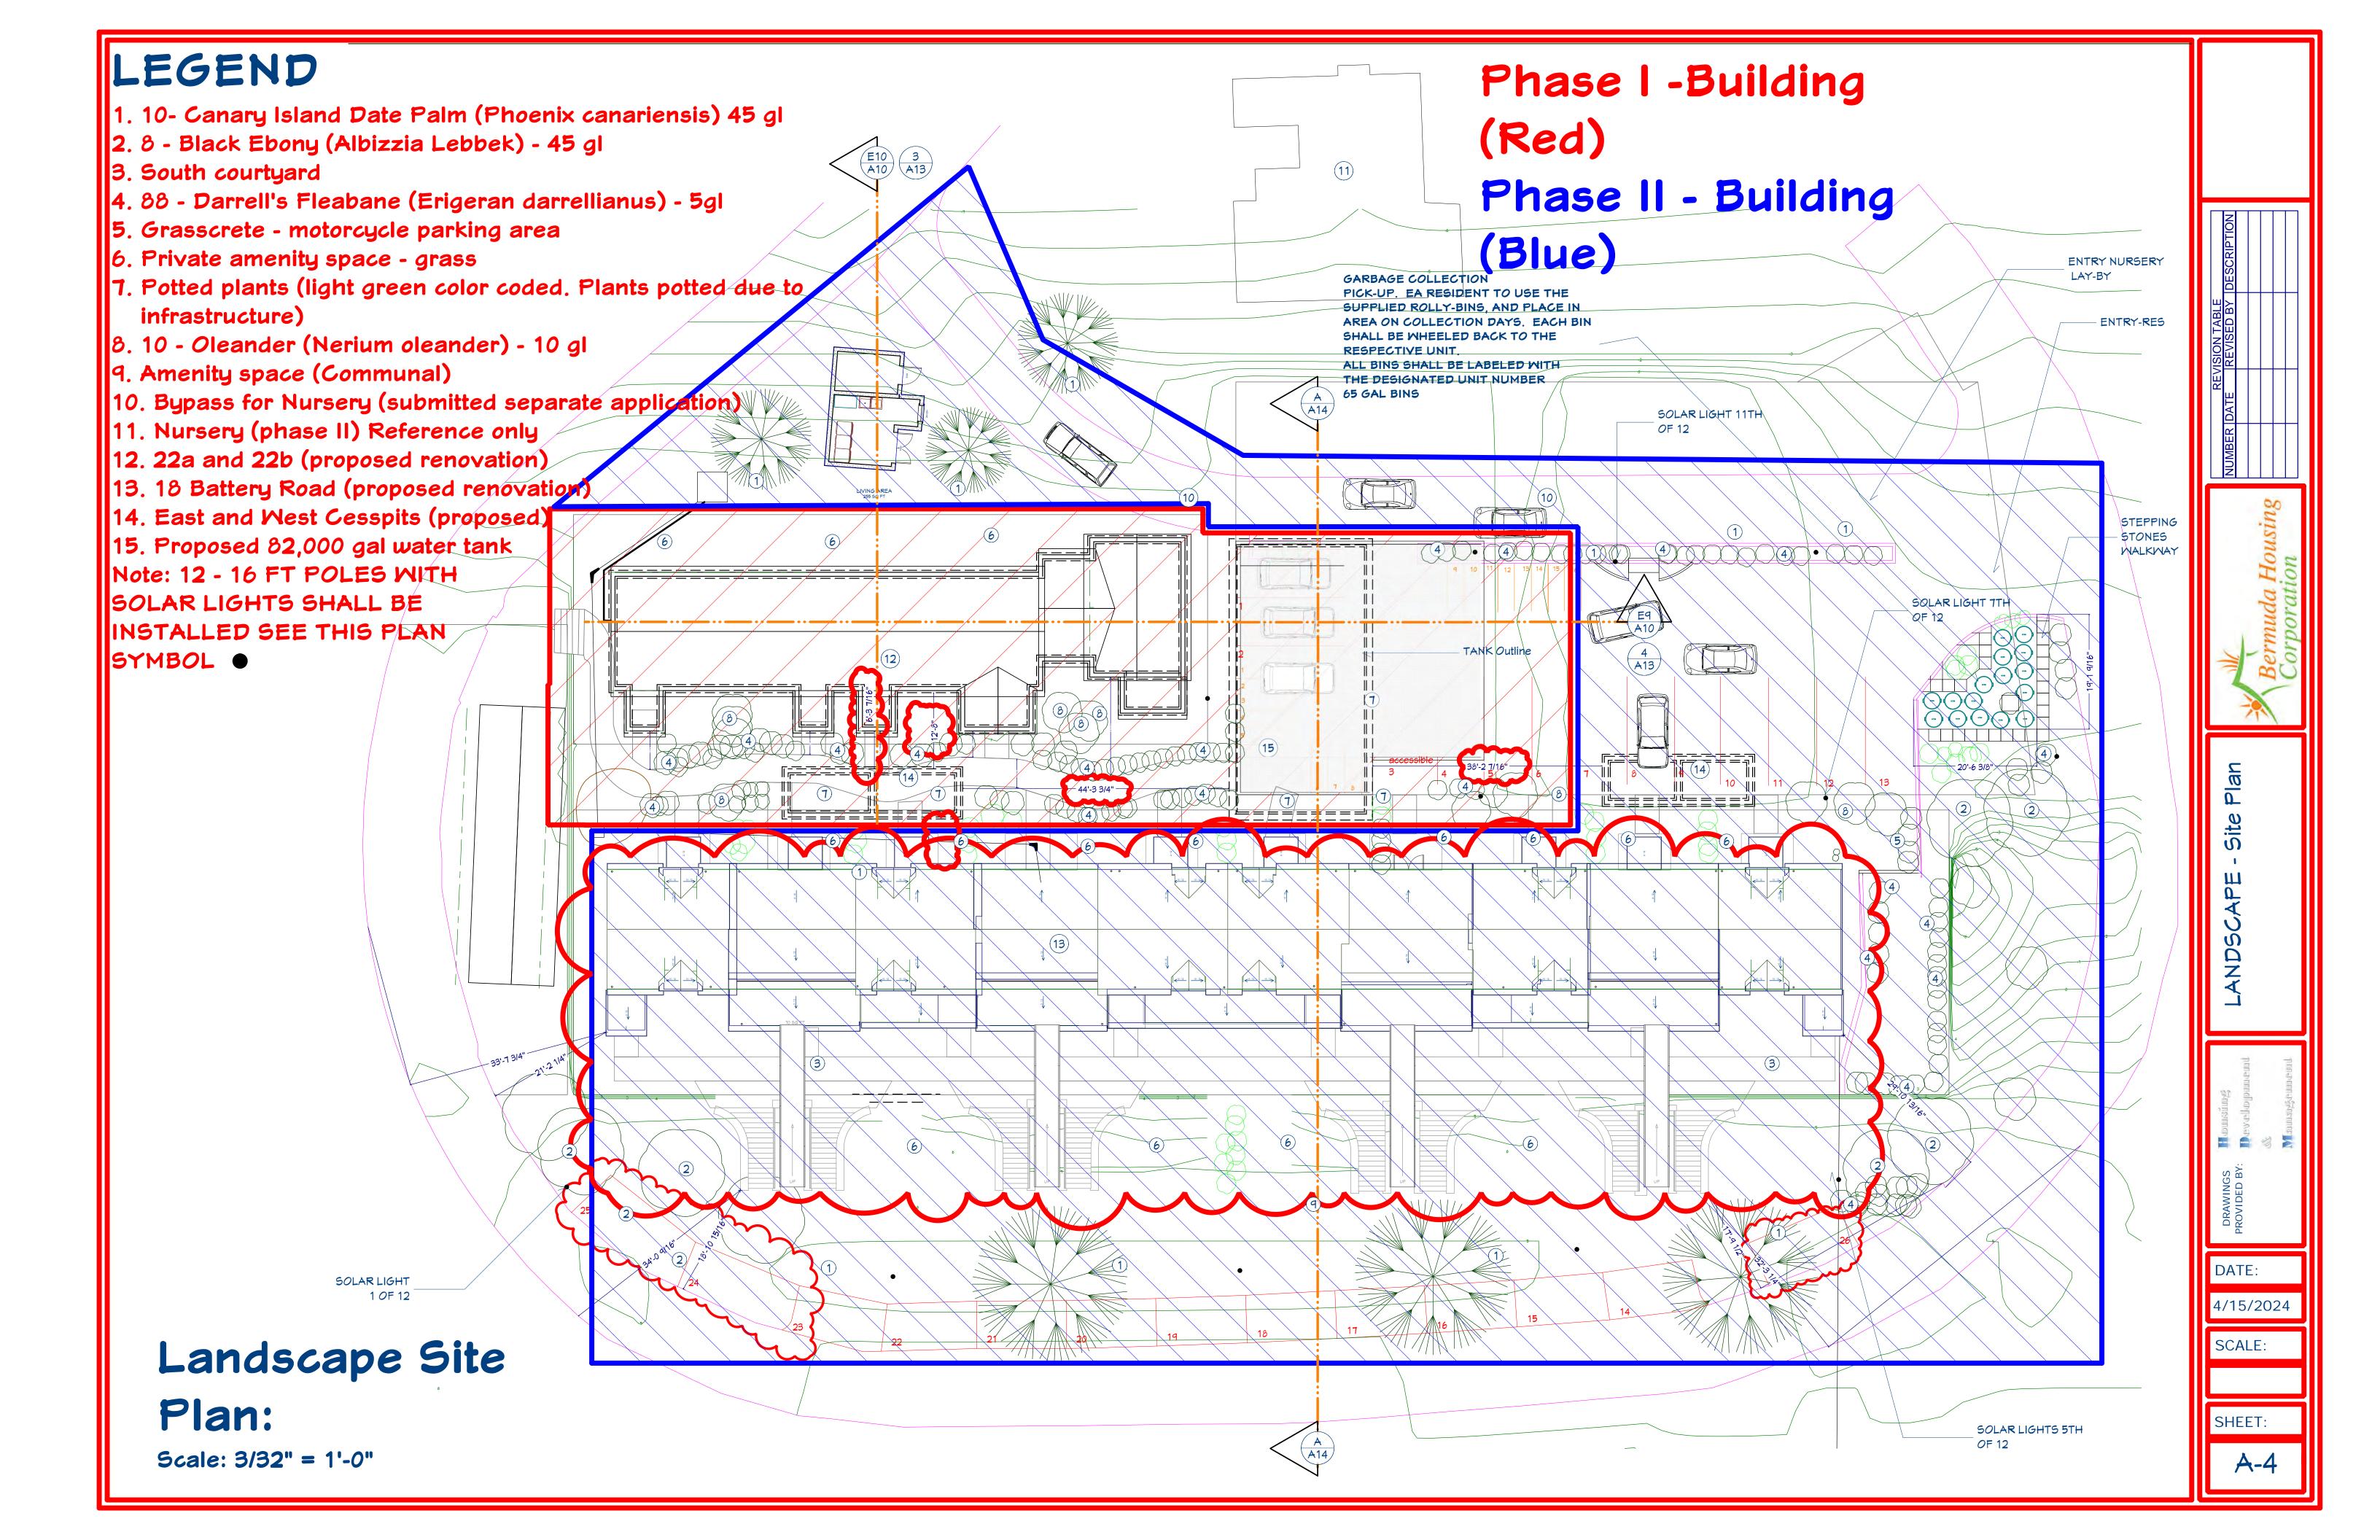



18133 BHC BATTERY ROAD CIVIL DRAWINGS

CIVIL INDEX

COVER SHEET
SITE PLAN & DETAILS

C001 C101

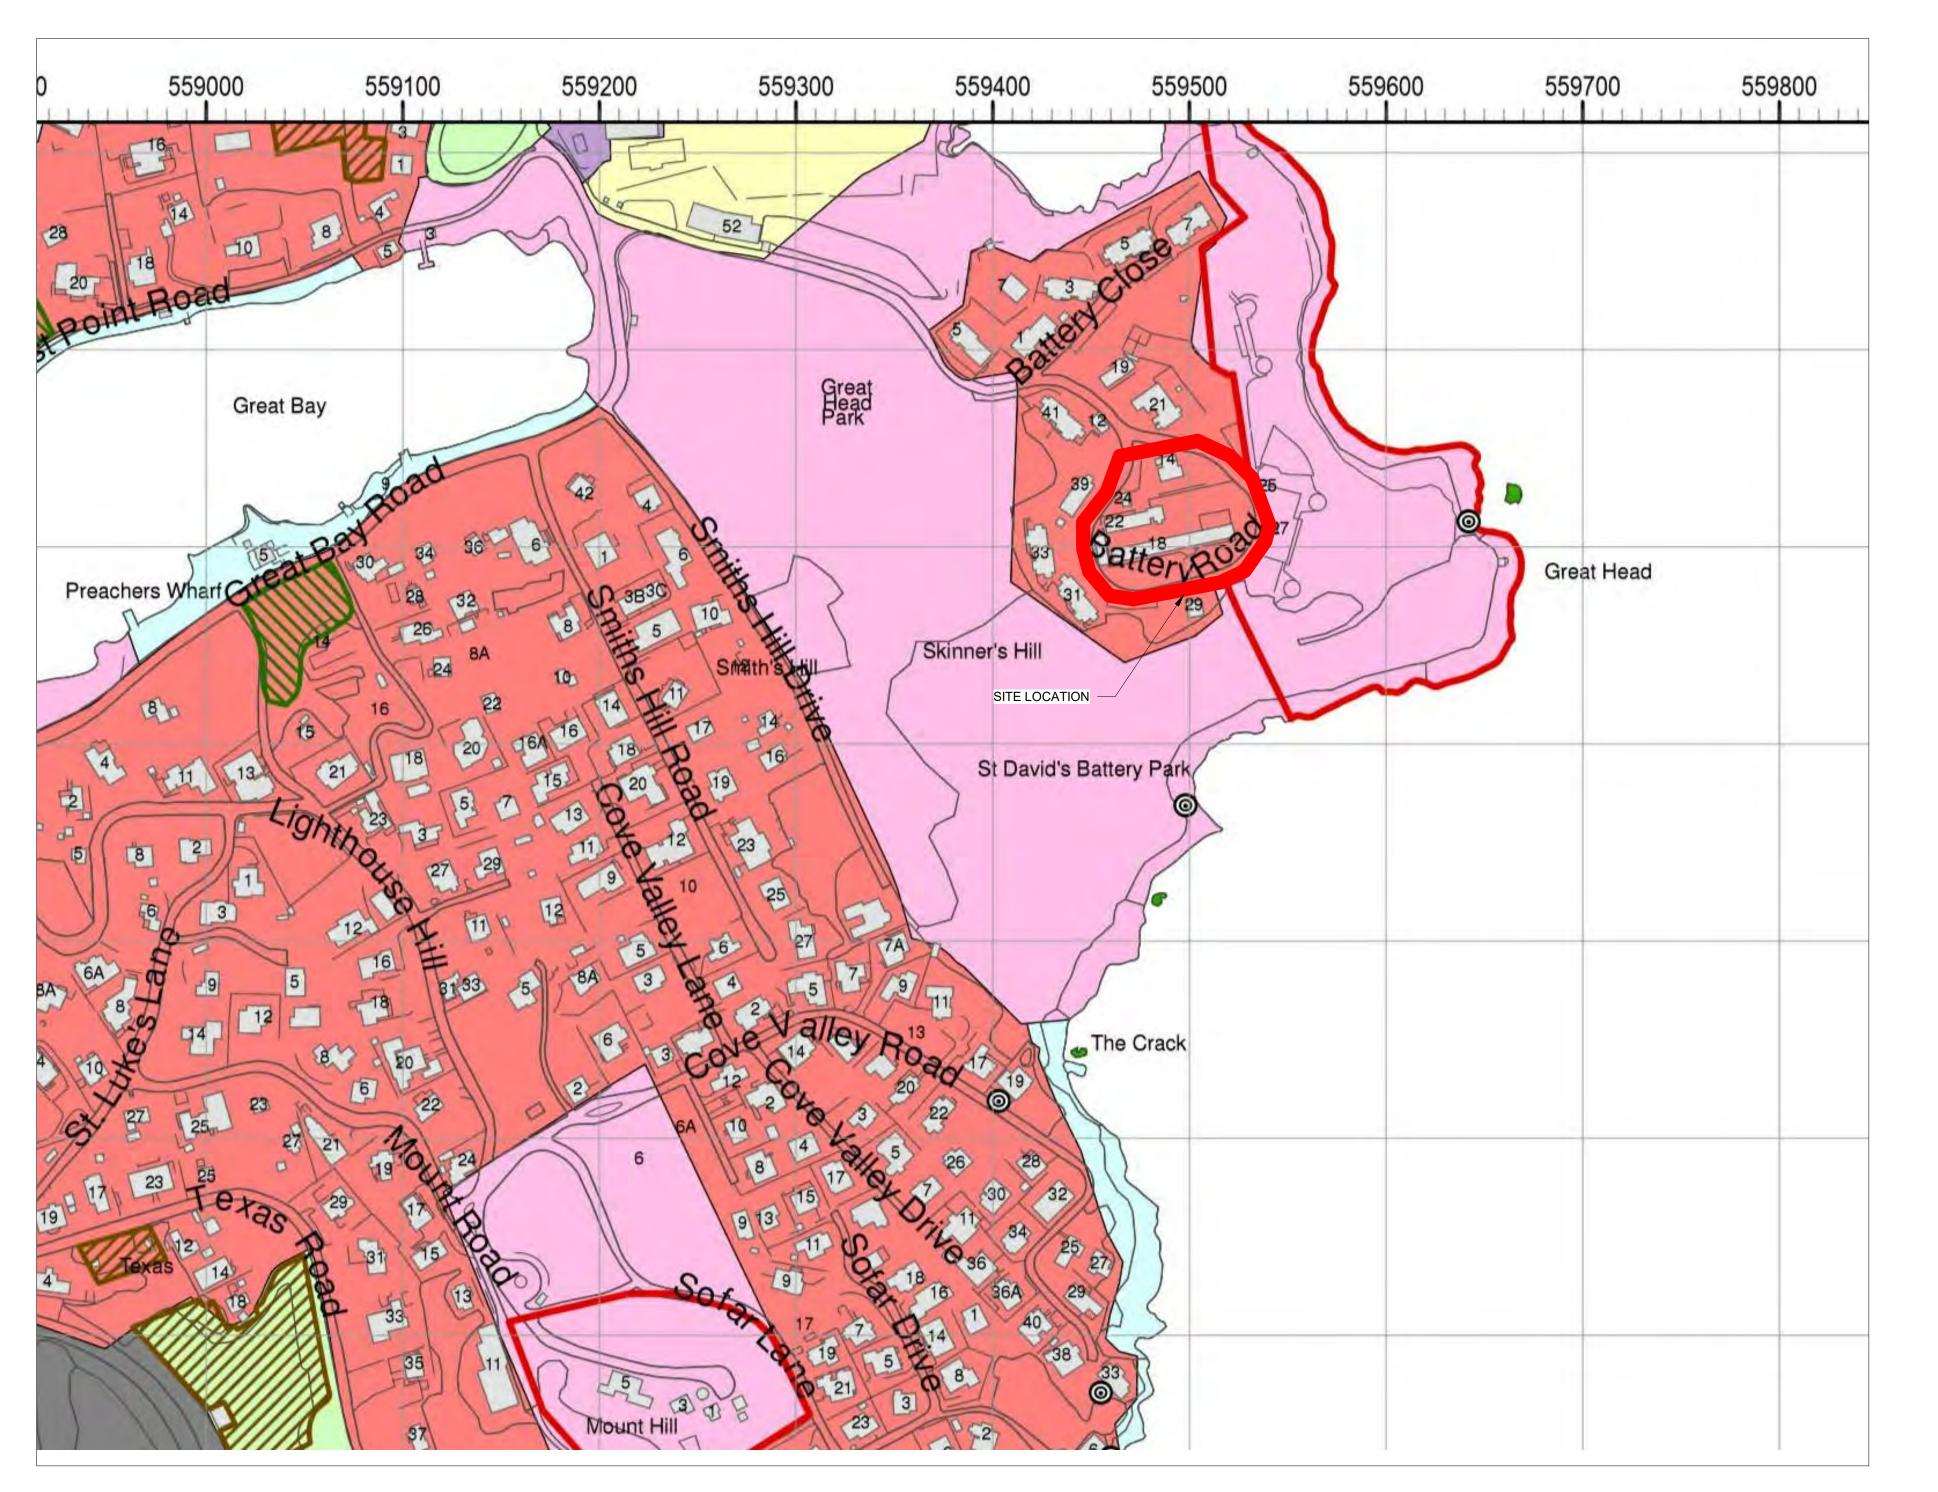

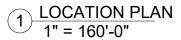

Copyright © 2019 Onsite Engineering Services Limited

This drawing is and shall remain the exclusive property of Onsite Engineering Services Limited (OES) and the reproduction and/or use in whole or in part is prohibited without prior written consent from OES.

The Contractor shall check and verify all levels, datum points and dimensions and report any discrepancy or omission to the Engineer prior to construction.

This drawing shall be read in conjunction with architectural and/or any other Consultants' documentation as may be applicable to the project. OES shall not be held responsible for lack of coordination on the part of the Contractor.

GENERAL NOTES:





ONSITE ENGINEERING SERVICES LTD.

Location: 27 Jubilee Rd. Devonshire DV06
Mail: P.O. Box HM 2170, Hamilton HMJX, Bermuda
Tel: 441-297-0592 | Fax: 441-295-1988 | Email: info@onsite.bm

PREPARED BY CHECKED BY APPROVED BY

PROJECT NAME


BHC BATTERY ROAD

18,20 & 22 BATTERY ROAD ST. GEORGES

SHEET TITLE

COVER SHEET

ISSUED FOR		
SCALE		SHEET SIZE
1" = 160'-0"	1	24" x 36"
PROJECT NO	SHEET NO	REVISION
18133	C001	

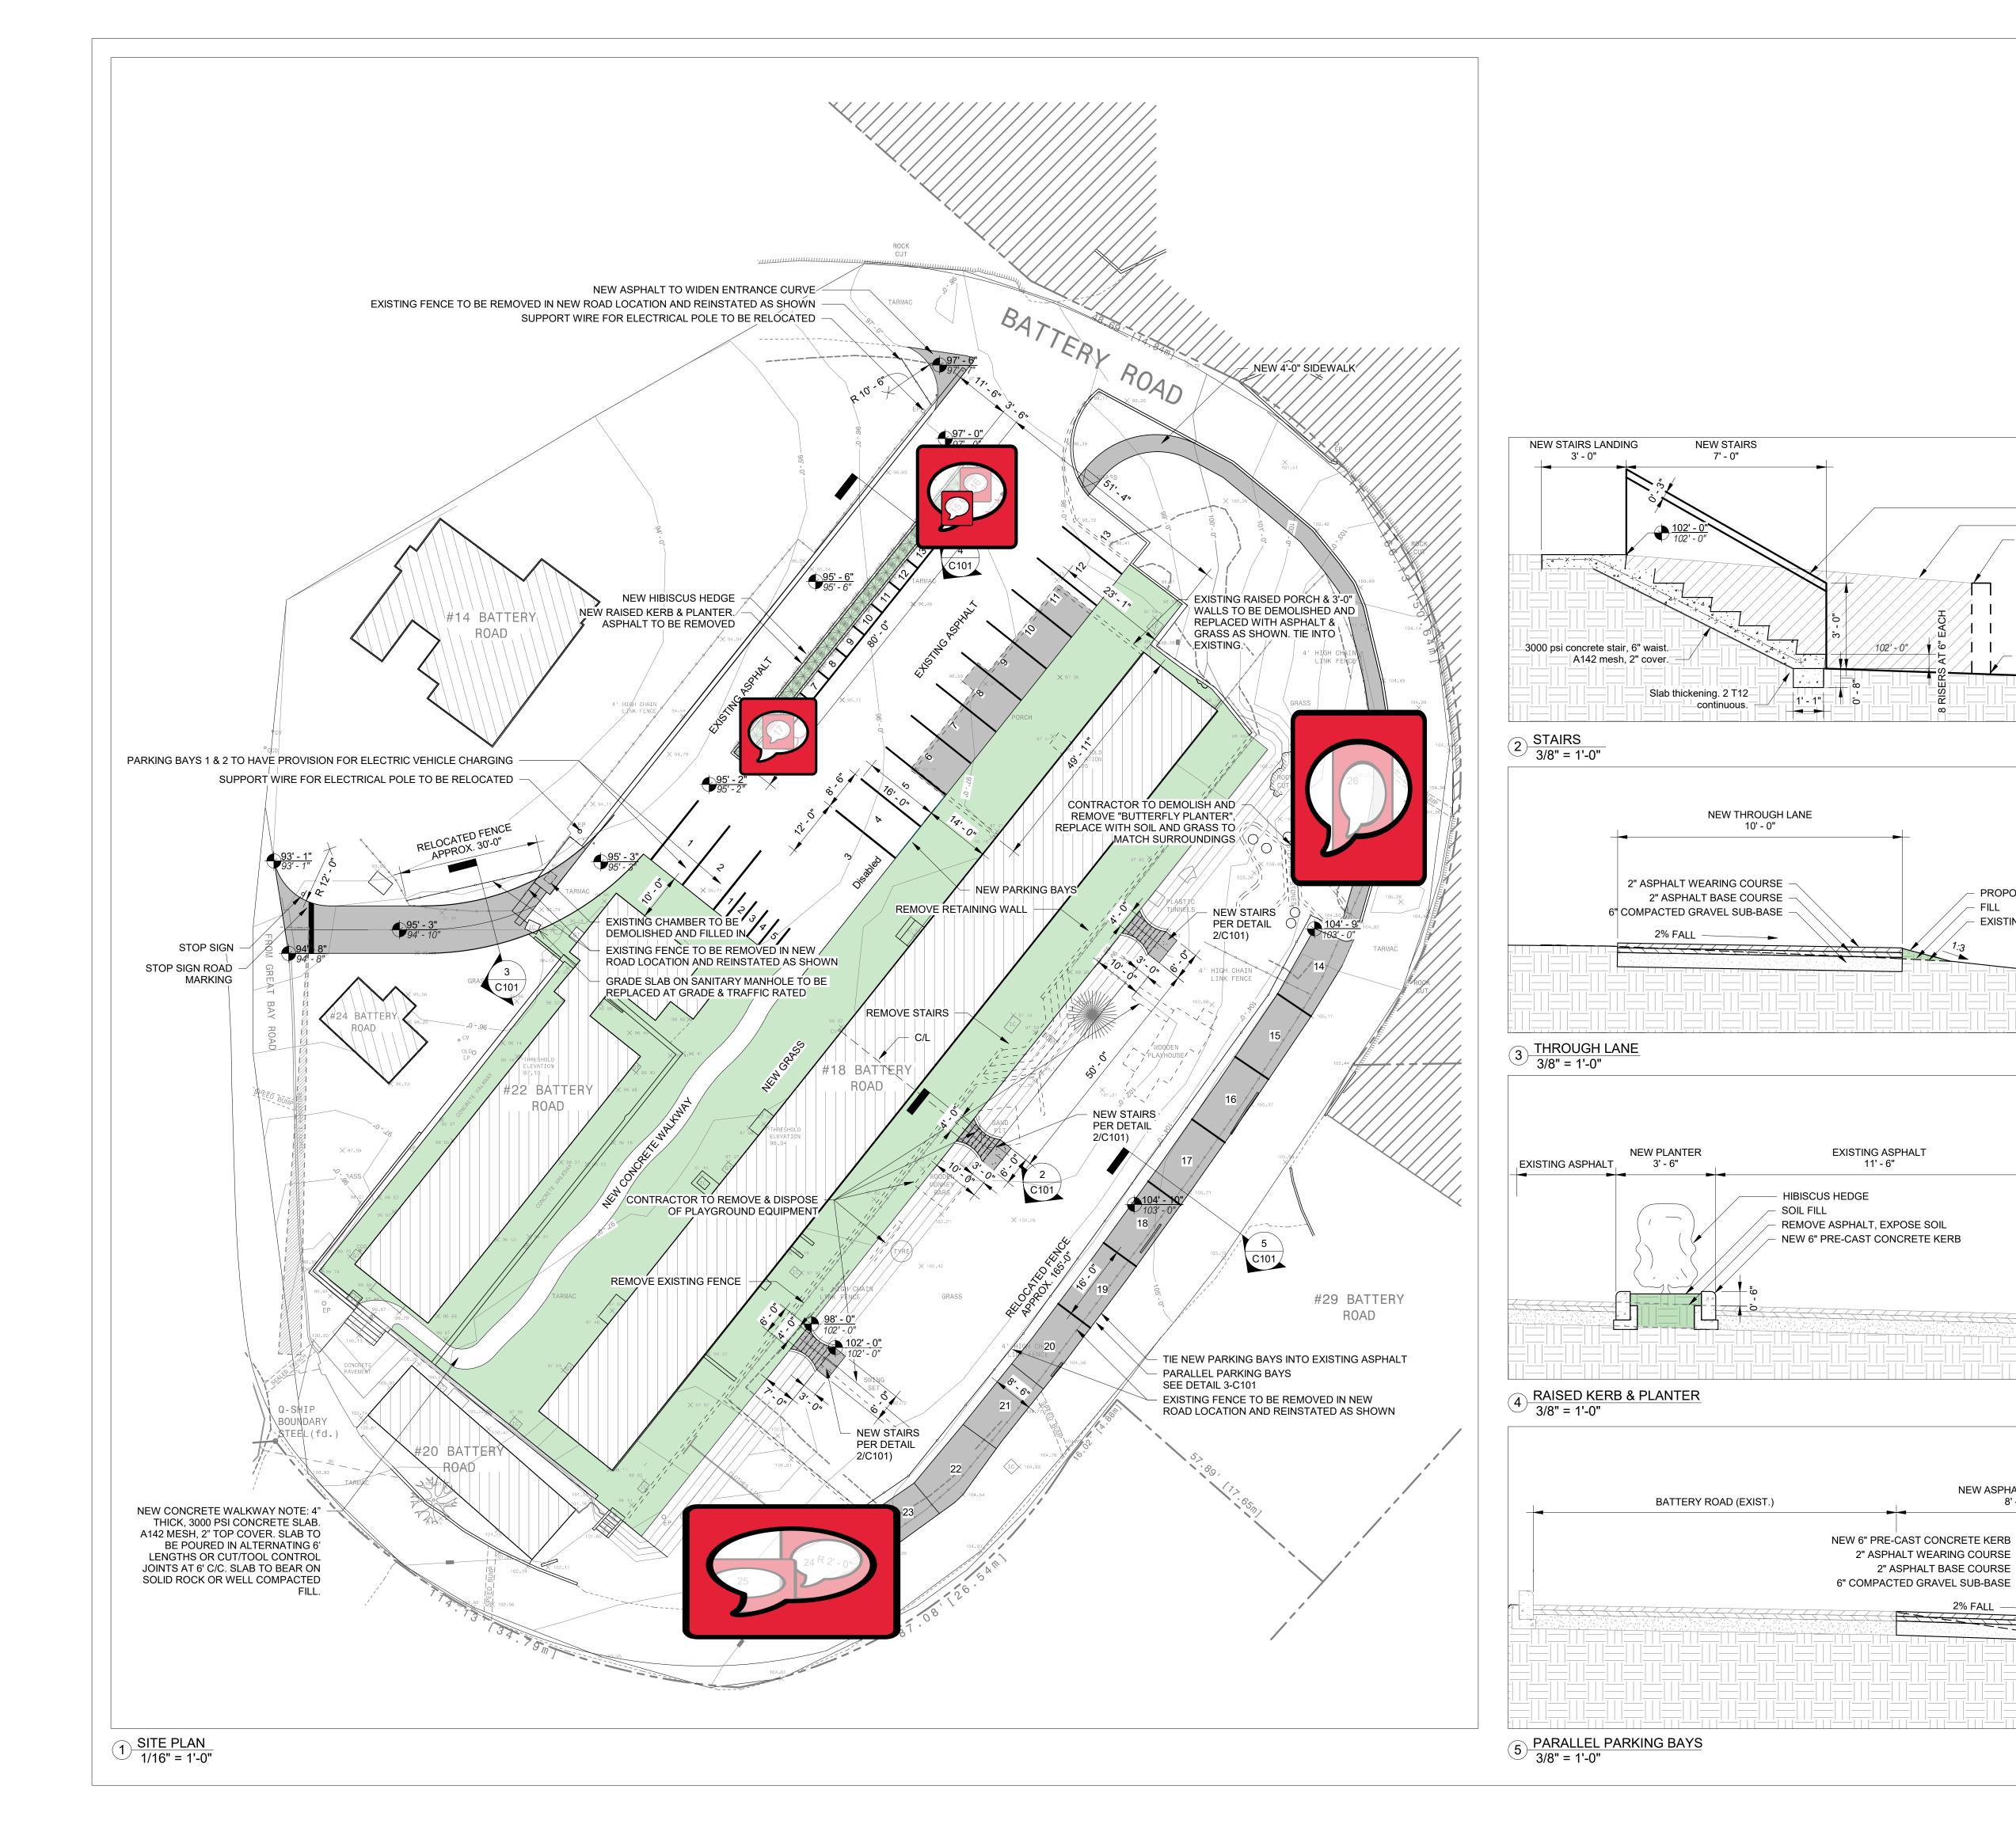

Copyright © 2019 Onsite Engineering Services Limited

This drawing is and shall remain the exclusive property of Onsite Engineering Services Limited (OES) and the reproduction and/or use in whole or in part is prohibited without prior written consent from OES.

The Contractor shall check and verify all levels, datum points and dimensions and report any discrepancy or omission to the Engineer prior to construction.

This drawing shall be read in conjunction with architectural and/or any other Consultants' documentation as may be applicable to the project. OES shall not be held responsible for lack of coordination on the part of the Contractor.

GENERAL NOTES:

SITE LEGEND

90' - 0" SIGHTLINE

90'-0" SIGHTLINE, 6'-0" FROM EDGE OF INTERSECTION

NOTE: ALL SIGNS SHOULD ADHERE TO THE TRAFFIC SIGNS REGULATION & GENERAL DIRECTIONS 2016 (UK)

PROPOSED ELEVATION

EXISTING ELEVATION

WALL RAILING **EXISTING GRADE** REMOVE WALL

PROPOSED GRADE

PROPOSED GRADE

GRASS

EXISTING GRADE

NEW ASPHALT PARKING

8' - 6"

NEW SLOPE


PROPOSED GRADE

EXISTING GRADE

PROPOSED ROAD

PROPOSED GRASS (ASPHALT/ CONCRETE TO BE REMOVED)

- 1. CONTOURS SHOWN IN 1'-0" INTERVALS 2. SOUTHERN PARKING BAYS TO TIE INTO FIELD AT 1:3
- 3. WHERE REMOVING ASPHALT & CONCRETE SURFACES, EXISTING INSPECTION CHAMBERS & GREASE TRAPS TO REMAIN IN PLACE

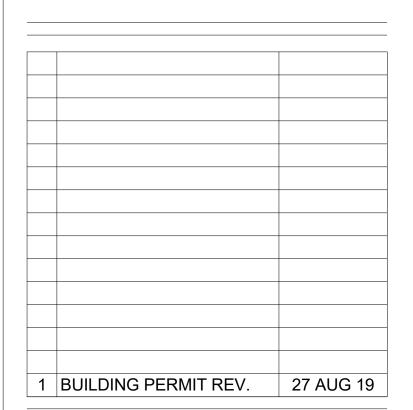



ONSITE ENGINEERING SERVICES LTD. Location: 27 Jubilee Rd. Devonshire DV06

CRB

Mail: P.O. Box HM 2170, Hamilton HMJX, Bermuda Tel: 441-297-0592 | Fax: 441-295-1988 | Email: info@onsite.bm **CHECKED BY** APPROVED BY

PROJECT NAME


BHC BATTERY ROAD

18,20 & 22 BATTERY ROAD ST. GEORGES

SHEET TITLE

SITE PLAN & DETAILS

ISSUED FOR BUILDING PERM		IT REV.	
SCALE	=	SHEET SIZE	
As indic	ated	24" x 36"	
PROJECT NO	SHEET NO	REVISIO	

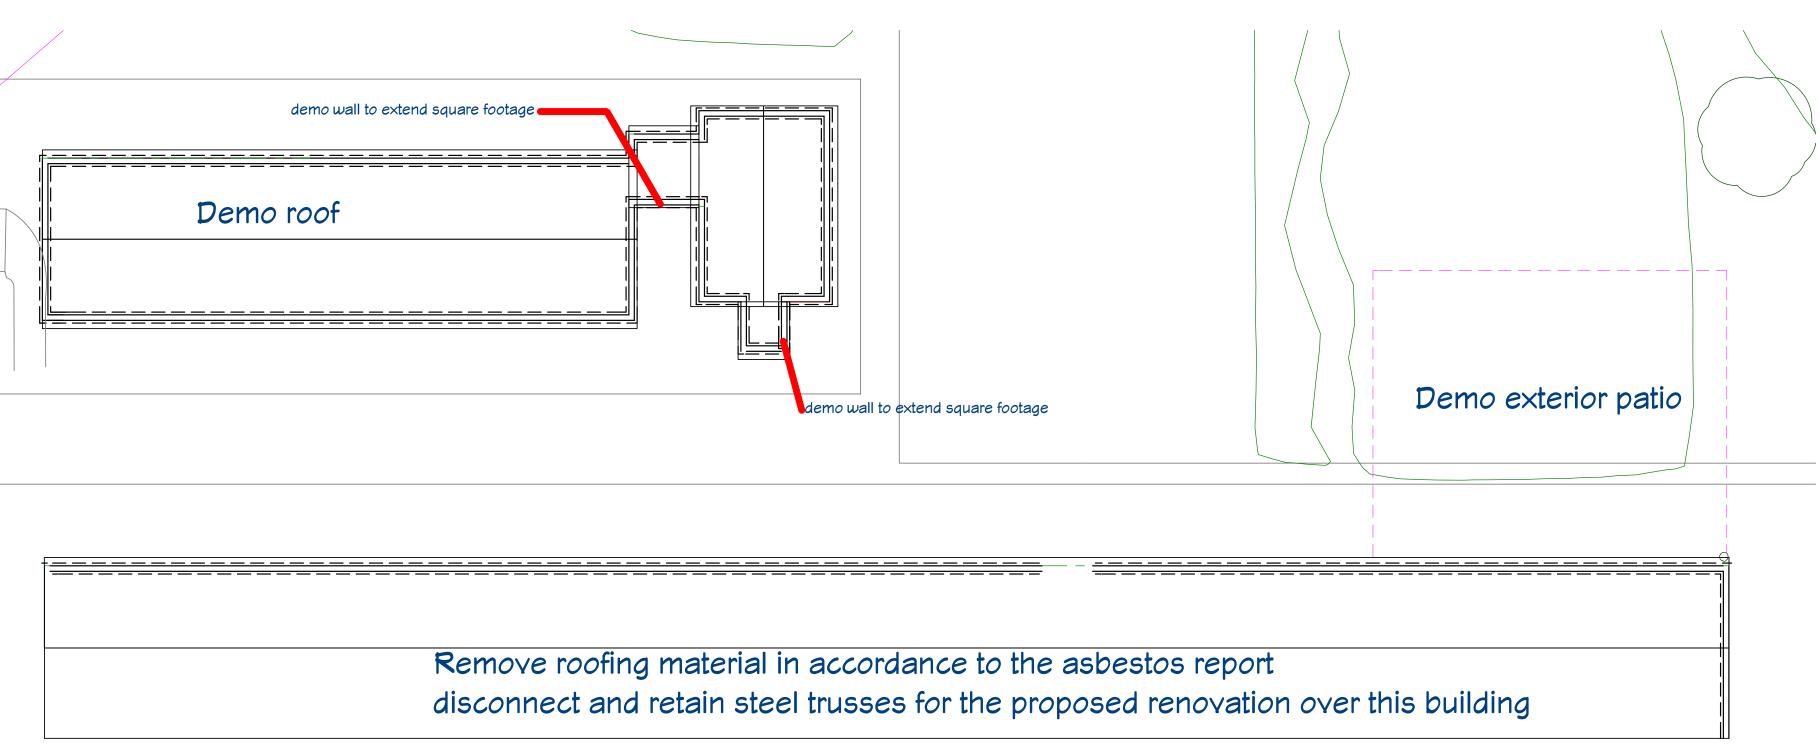

Site Plan:

Scale: 3/32" = 1'-0"

DEMOLITION NOTES

Access for vehicles/trucking of debris to be via Westcott Lane.

Remove walls, partitions, structural systems, Mechanical and Electrical services, and associated items as noted.

Finishes to be removed as required to suit new proposal - Refer to Owners Finishes Schedule.

Disconnect all power and illumination as necessary for the completion of removal operations. Abandoned services not to be extended or reused to be removed.

Disconnect all service piping necessary for the completion of removal operations. Cap and abandon service lines not to be extended or reused. Reroute services which must be mantained. Refer to Plumbing & Electrical drugs for details.

All removed equipment items, walls, Structural, Mechanical, Eletrical, and finish materials other than 'Owner salvaged' items shall be the sole responsibilty of the Contractor, and shall be carefully & appropriately removed from the site.

Existing utilities and service lines discovered during removal operations shall be immediately reported to the Contractor

Provide suitable protection for adjacent existing areas before, during and following removal & demolition operations.

Debris shall be carefully removed using adequately enclosed containers to prevent unwanted debris spill during removal. No material shall be burned, stored or sold in either the building or on the site. All removed material and debris, unless

identified otherwise, shall become the Contractor's property and shall be removed immediately and completely from the building and the site.

Leave the site clean, ready for further construction.

Developmend


DRAWII


DATE:


4/15/2024


SCALE:


SHEET:

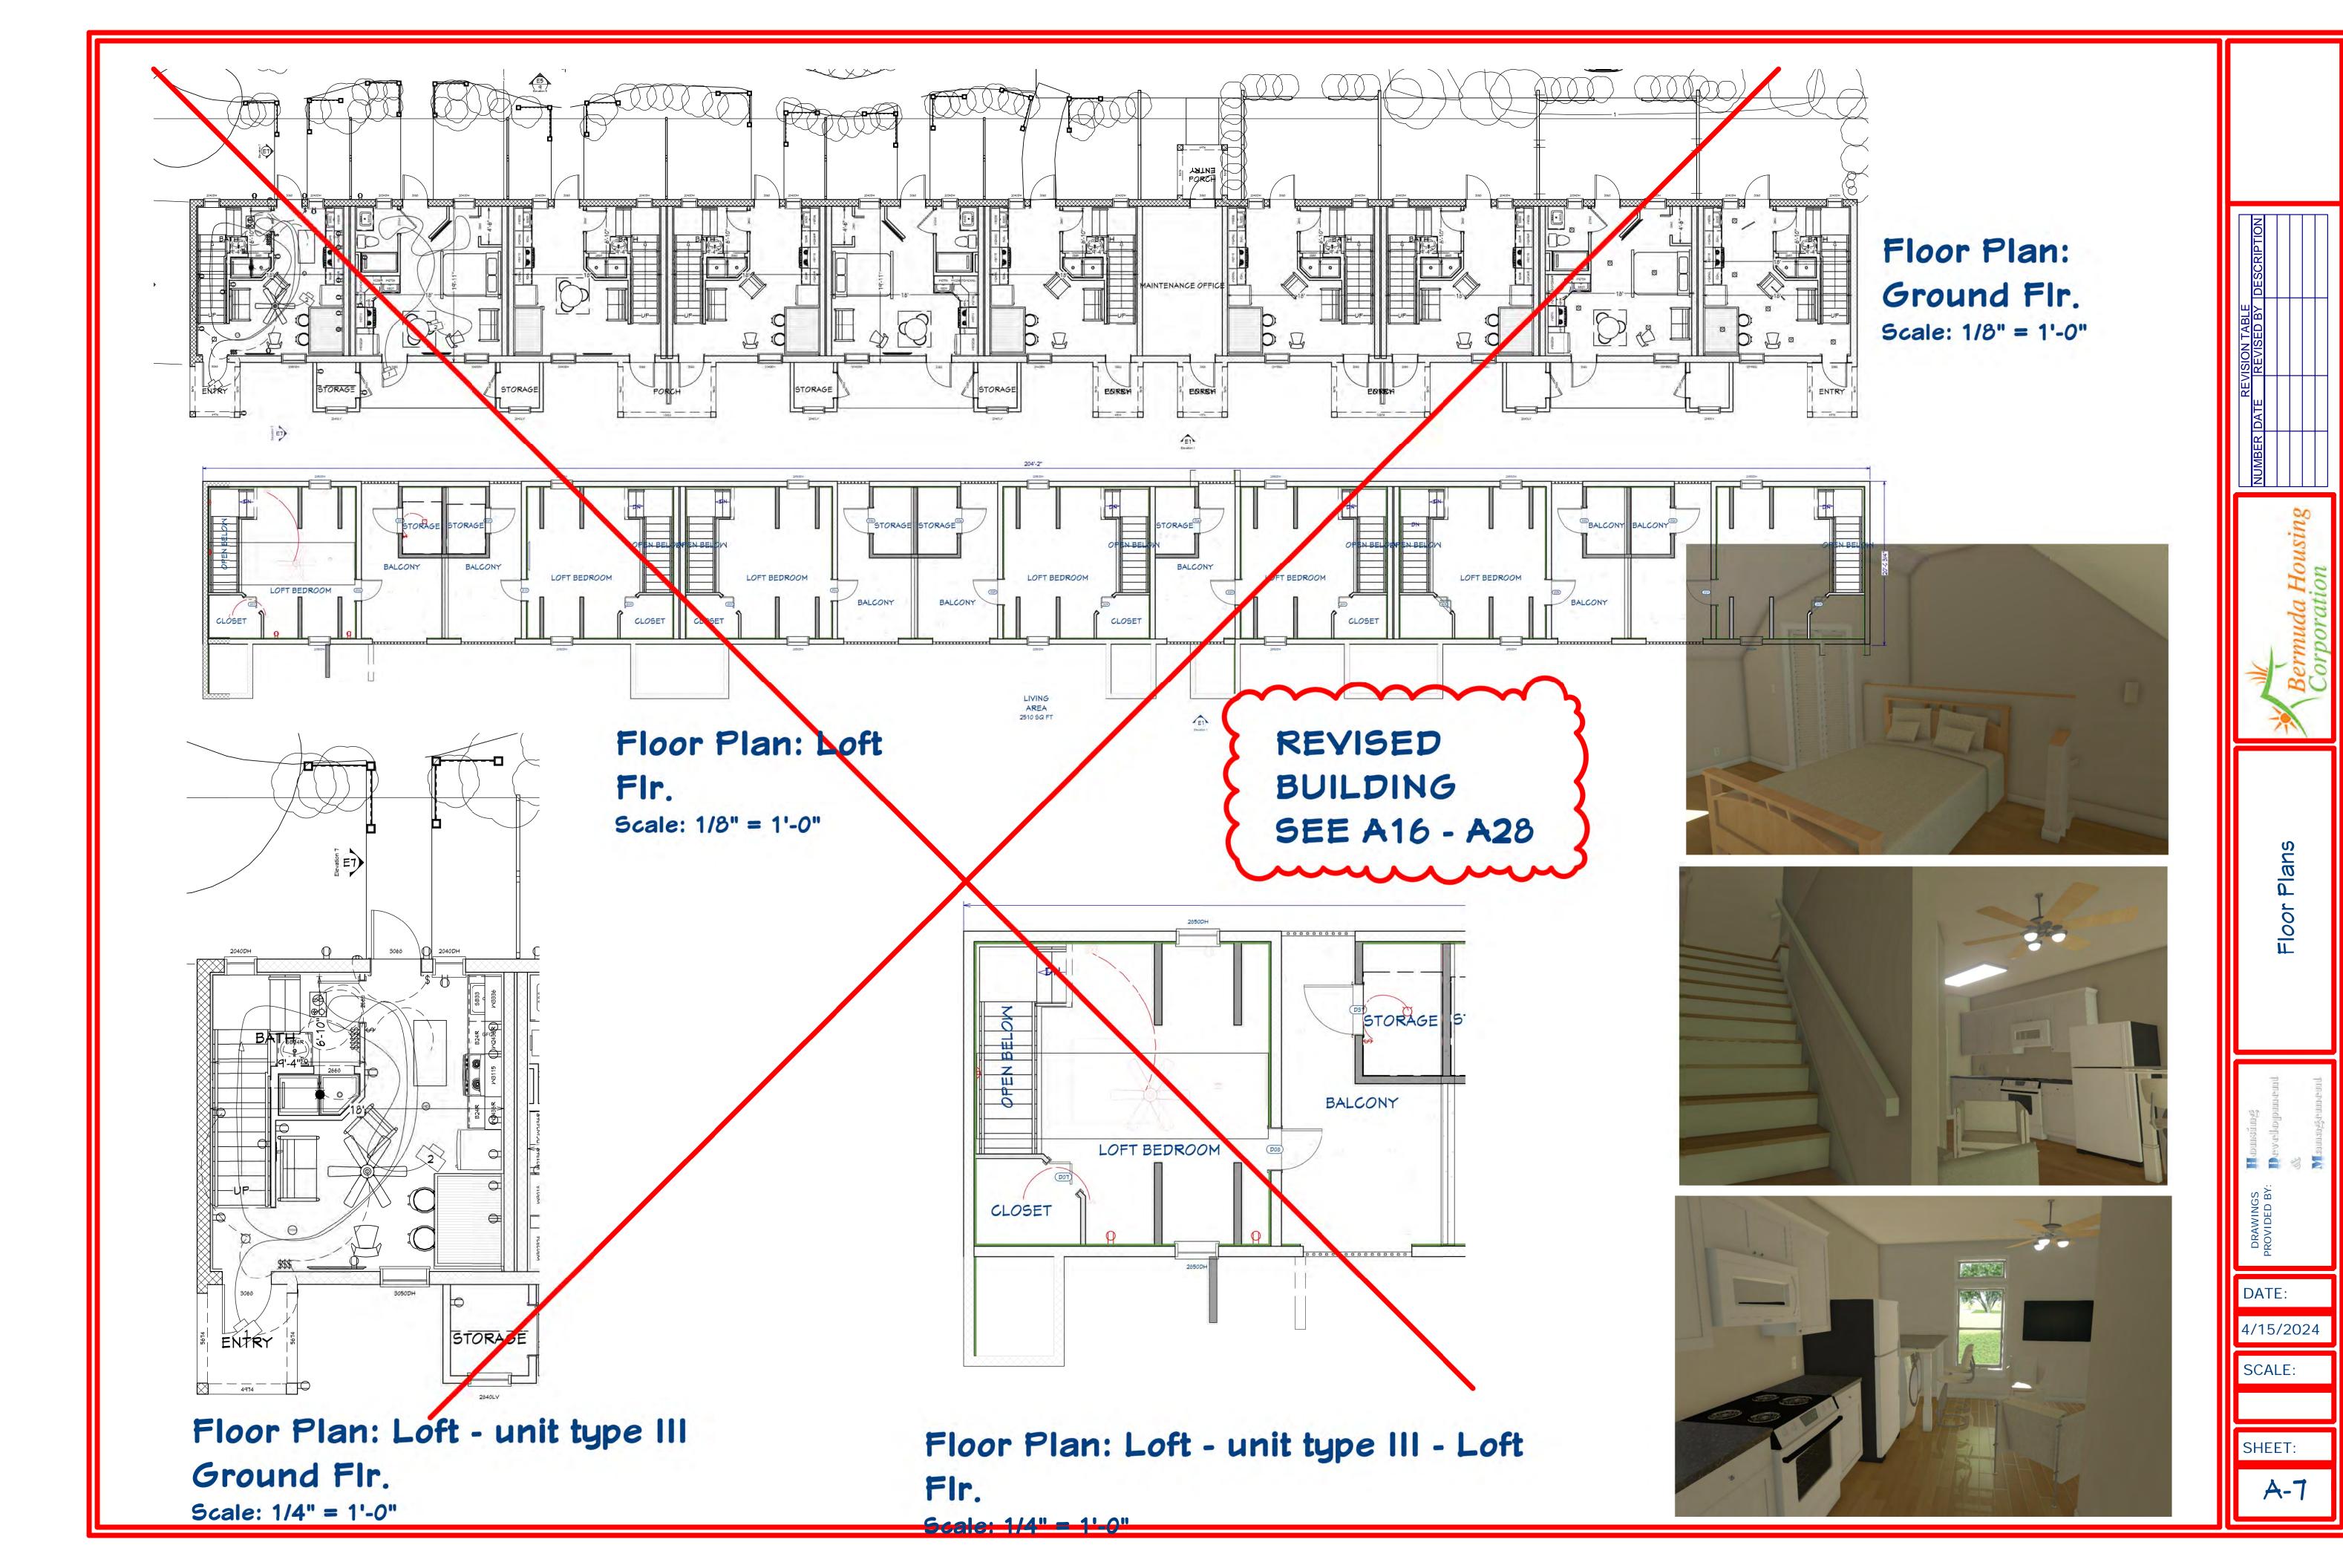

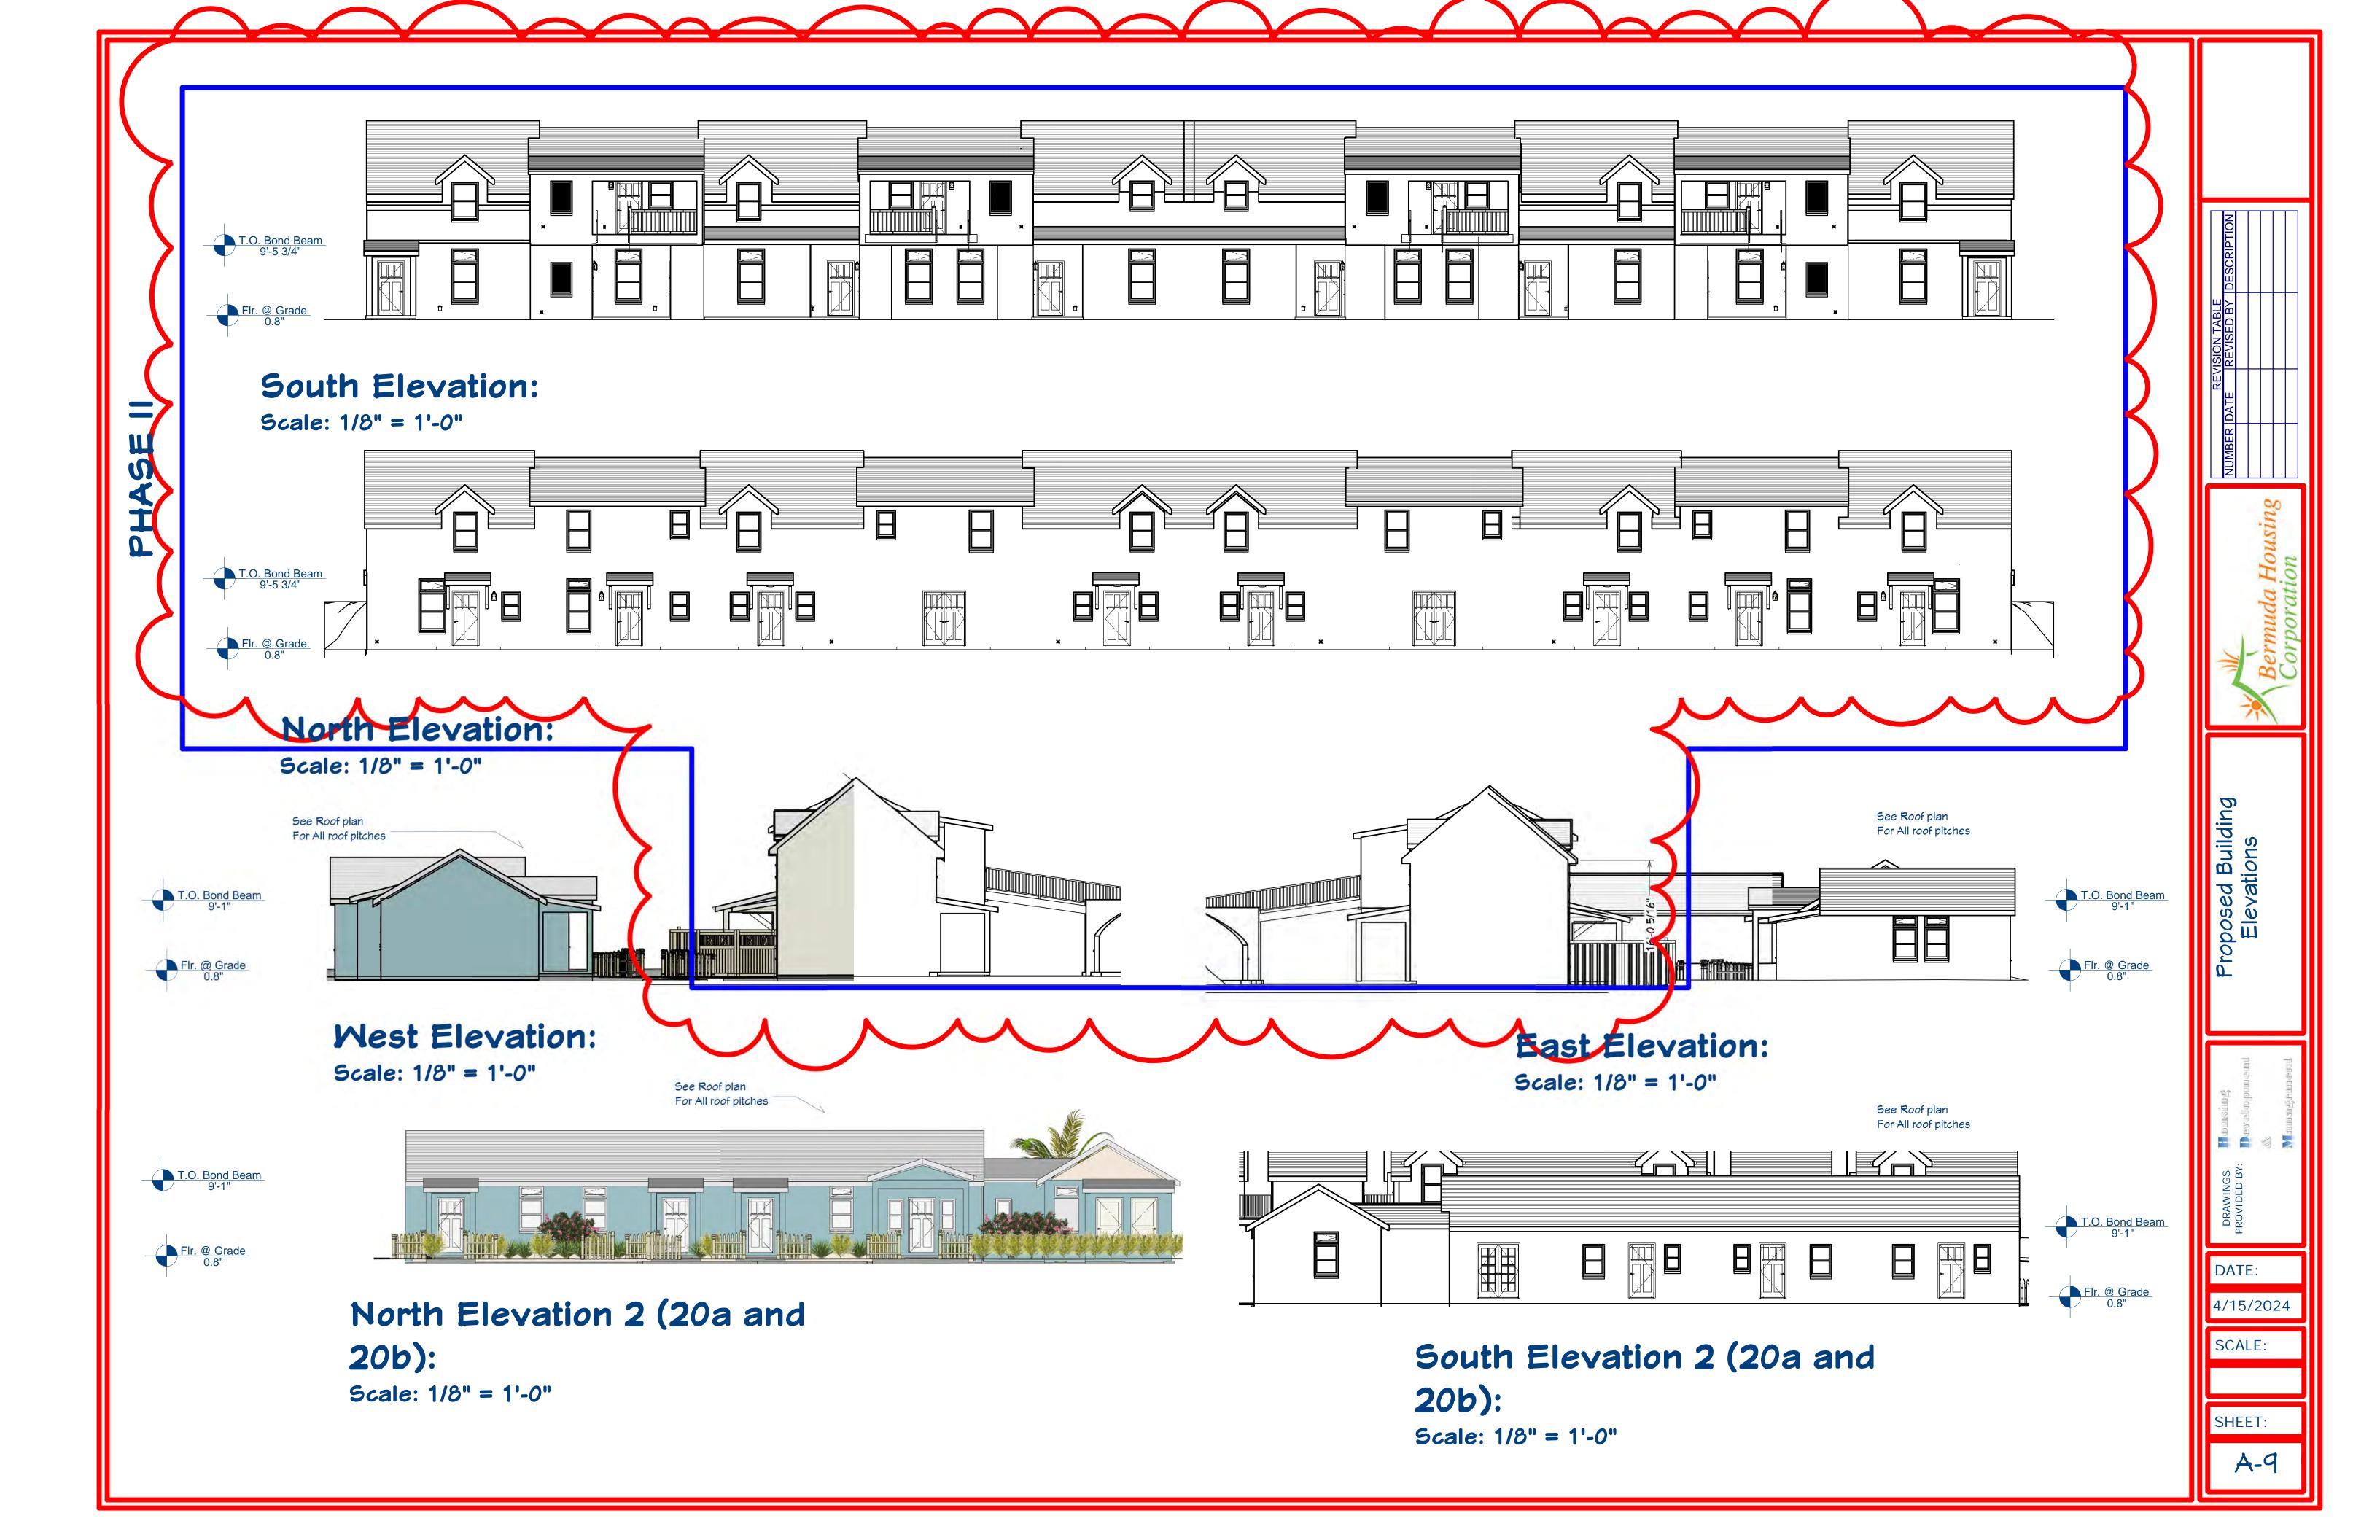

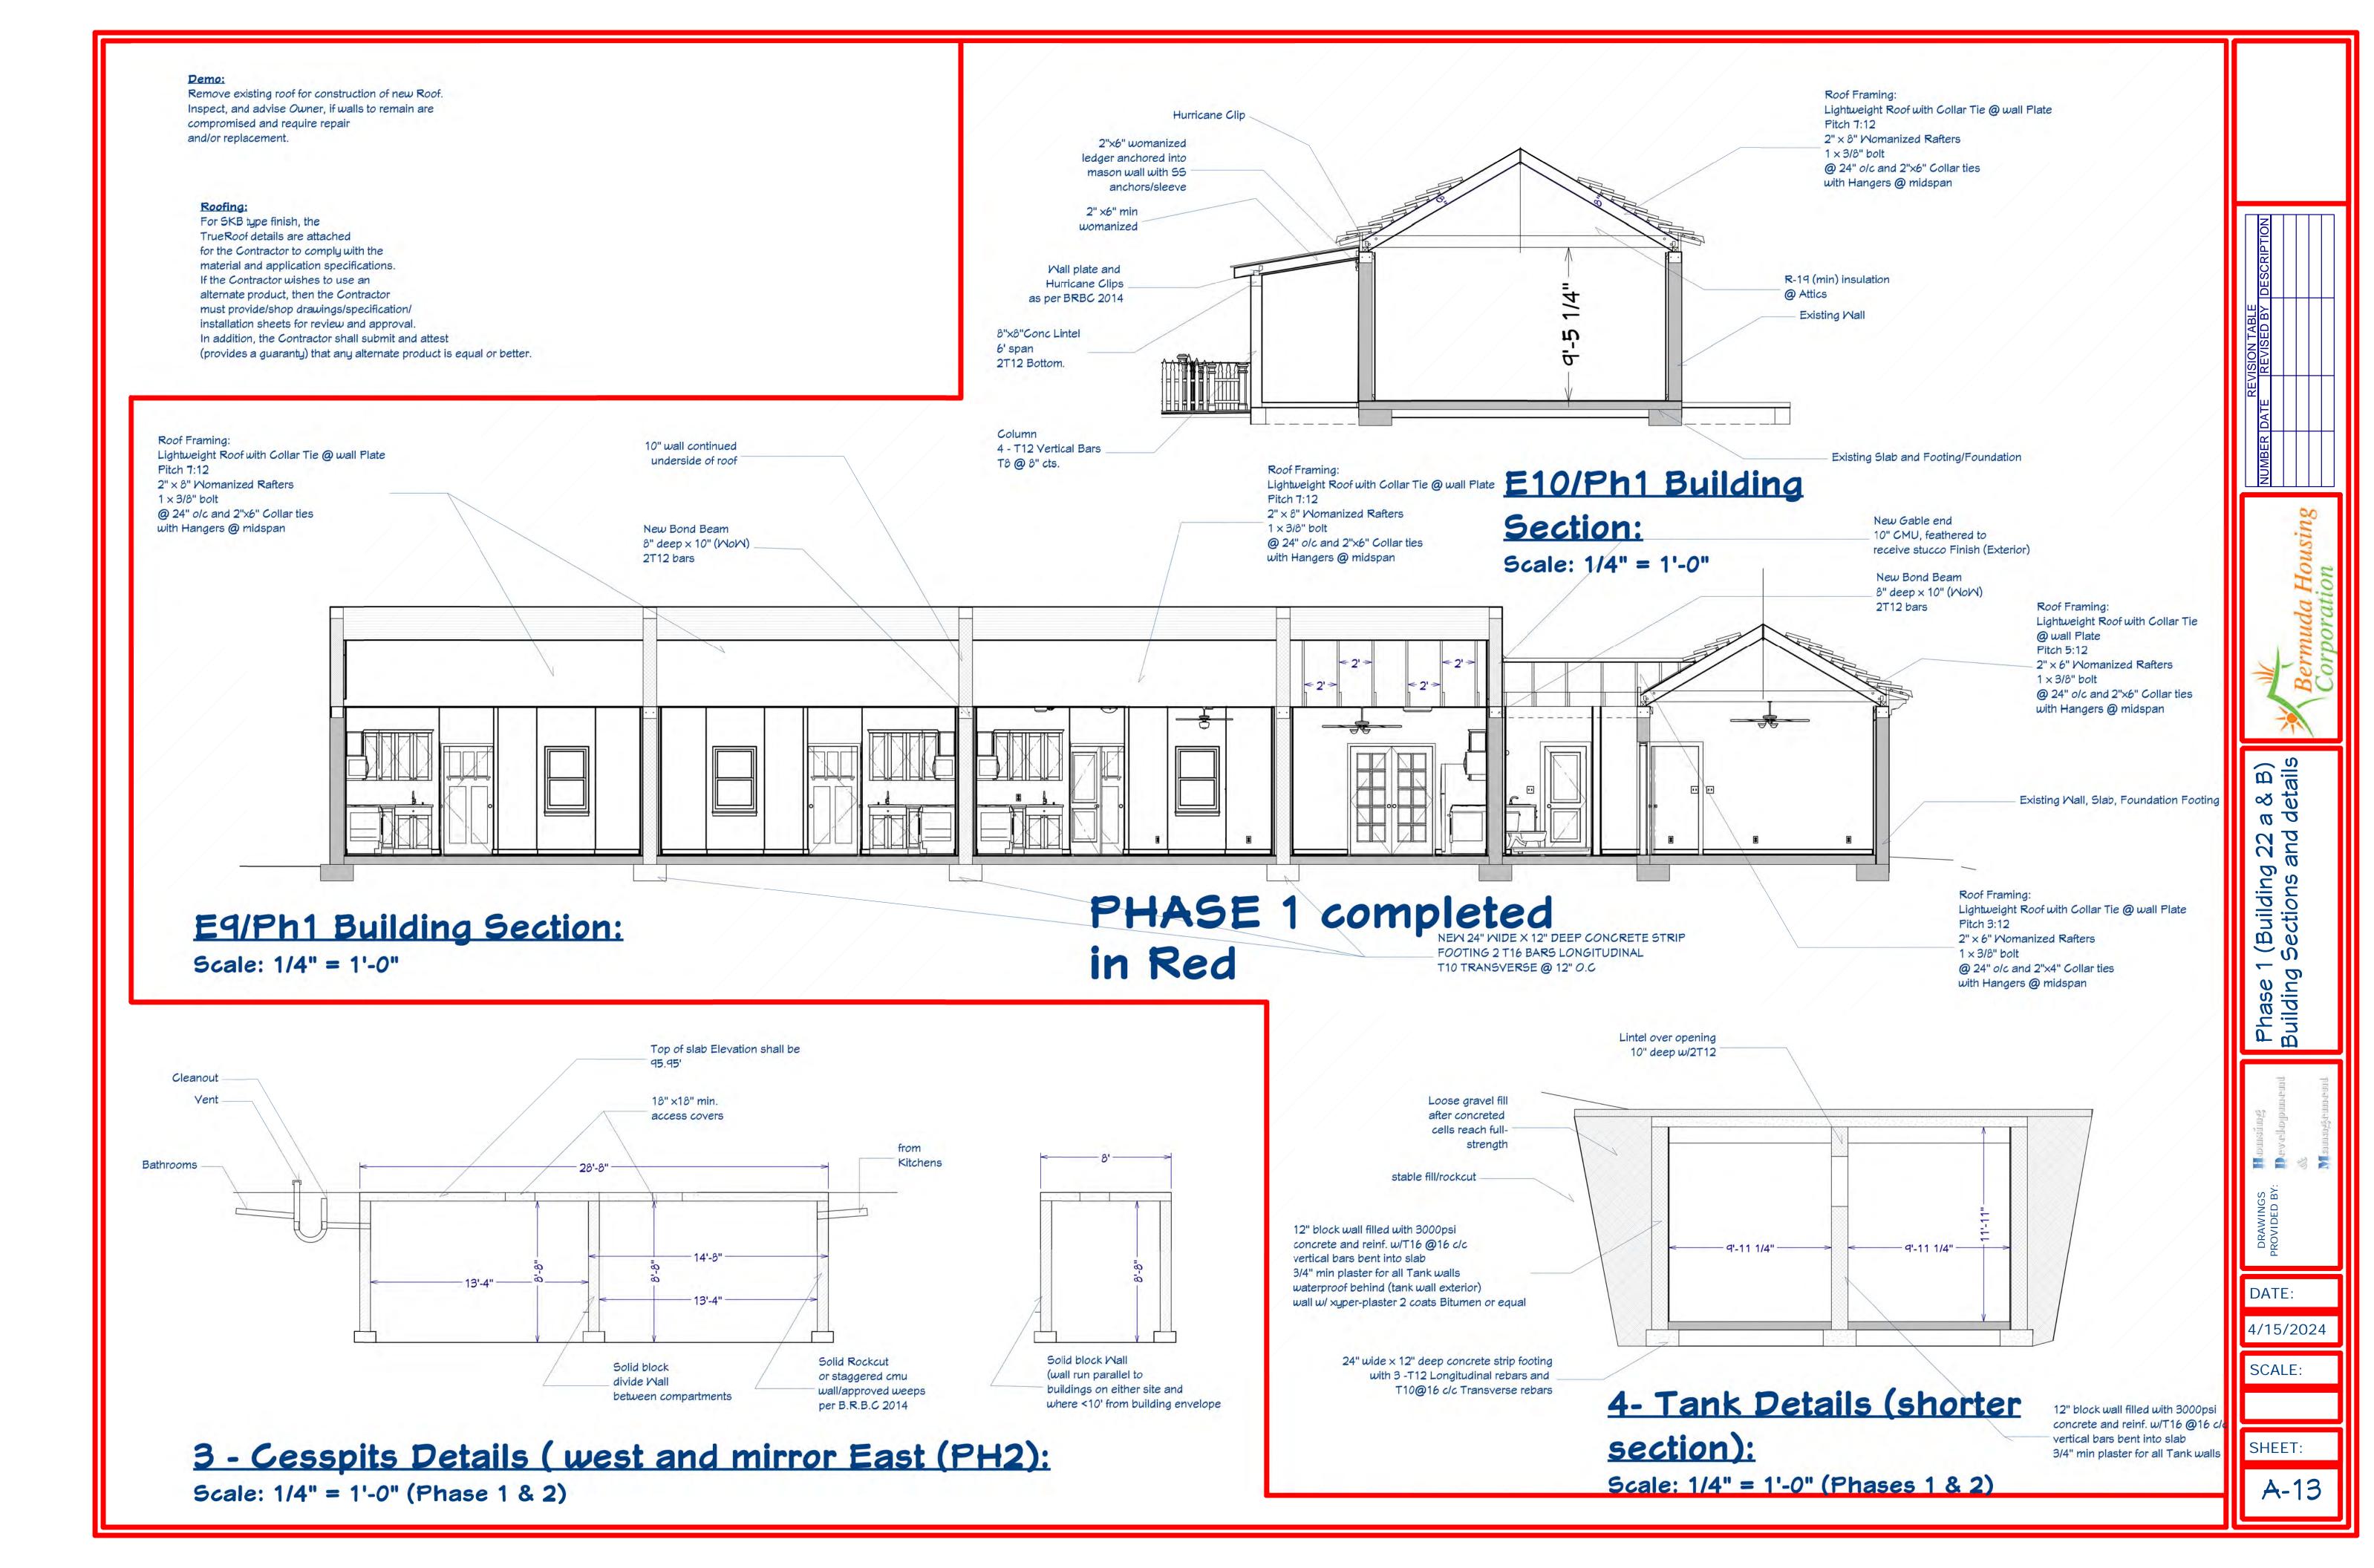

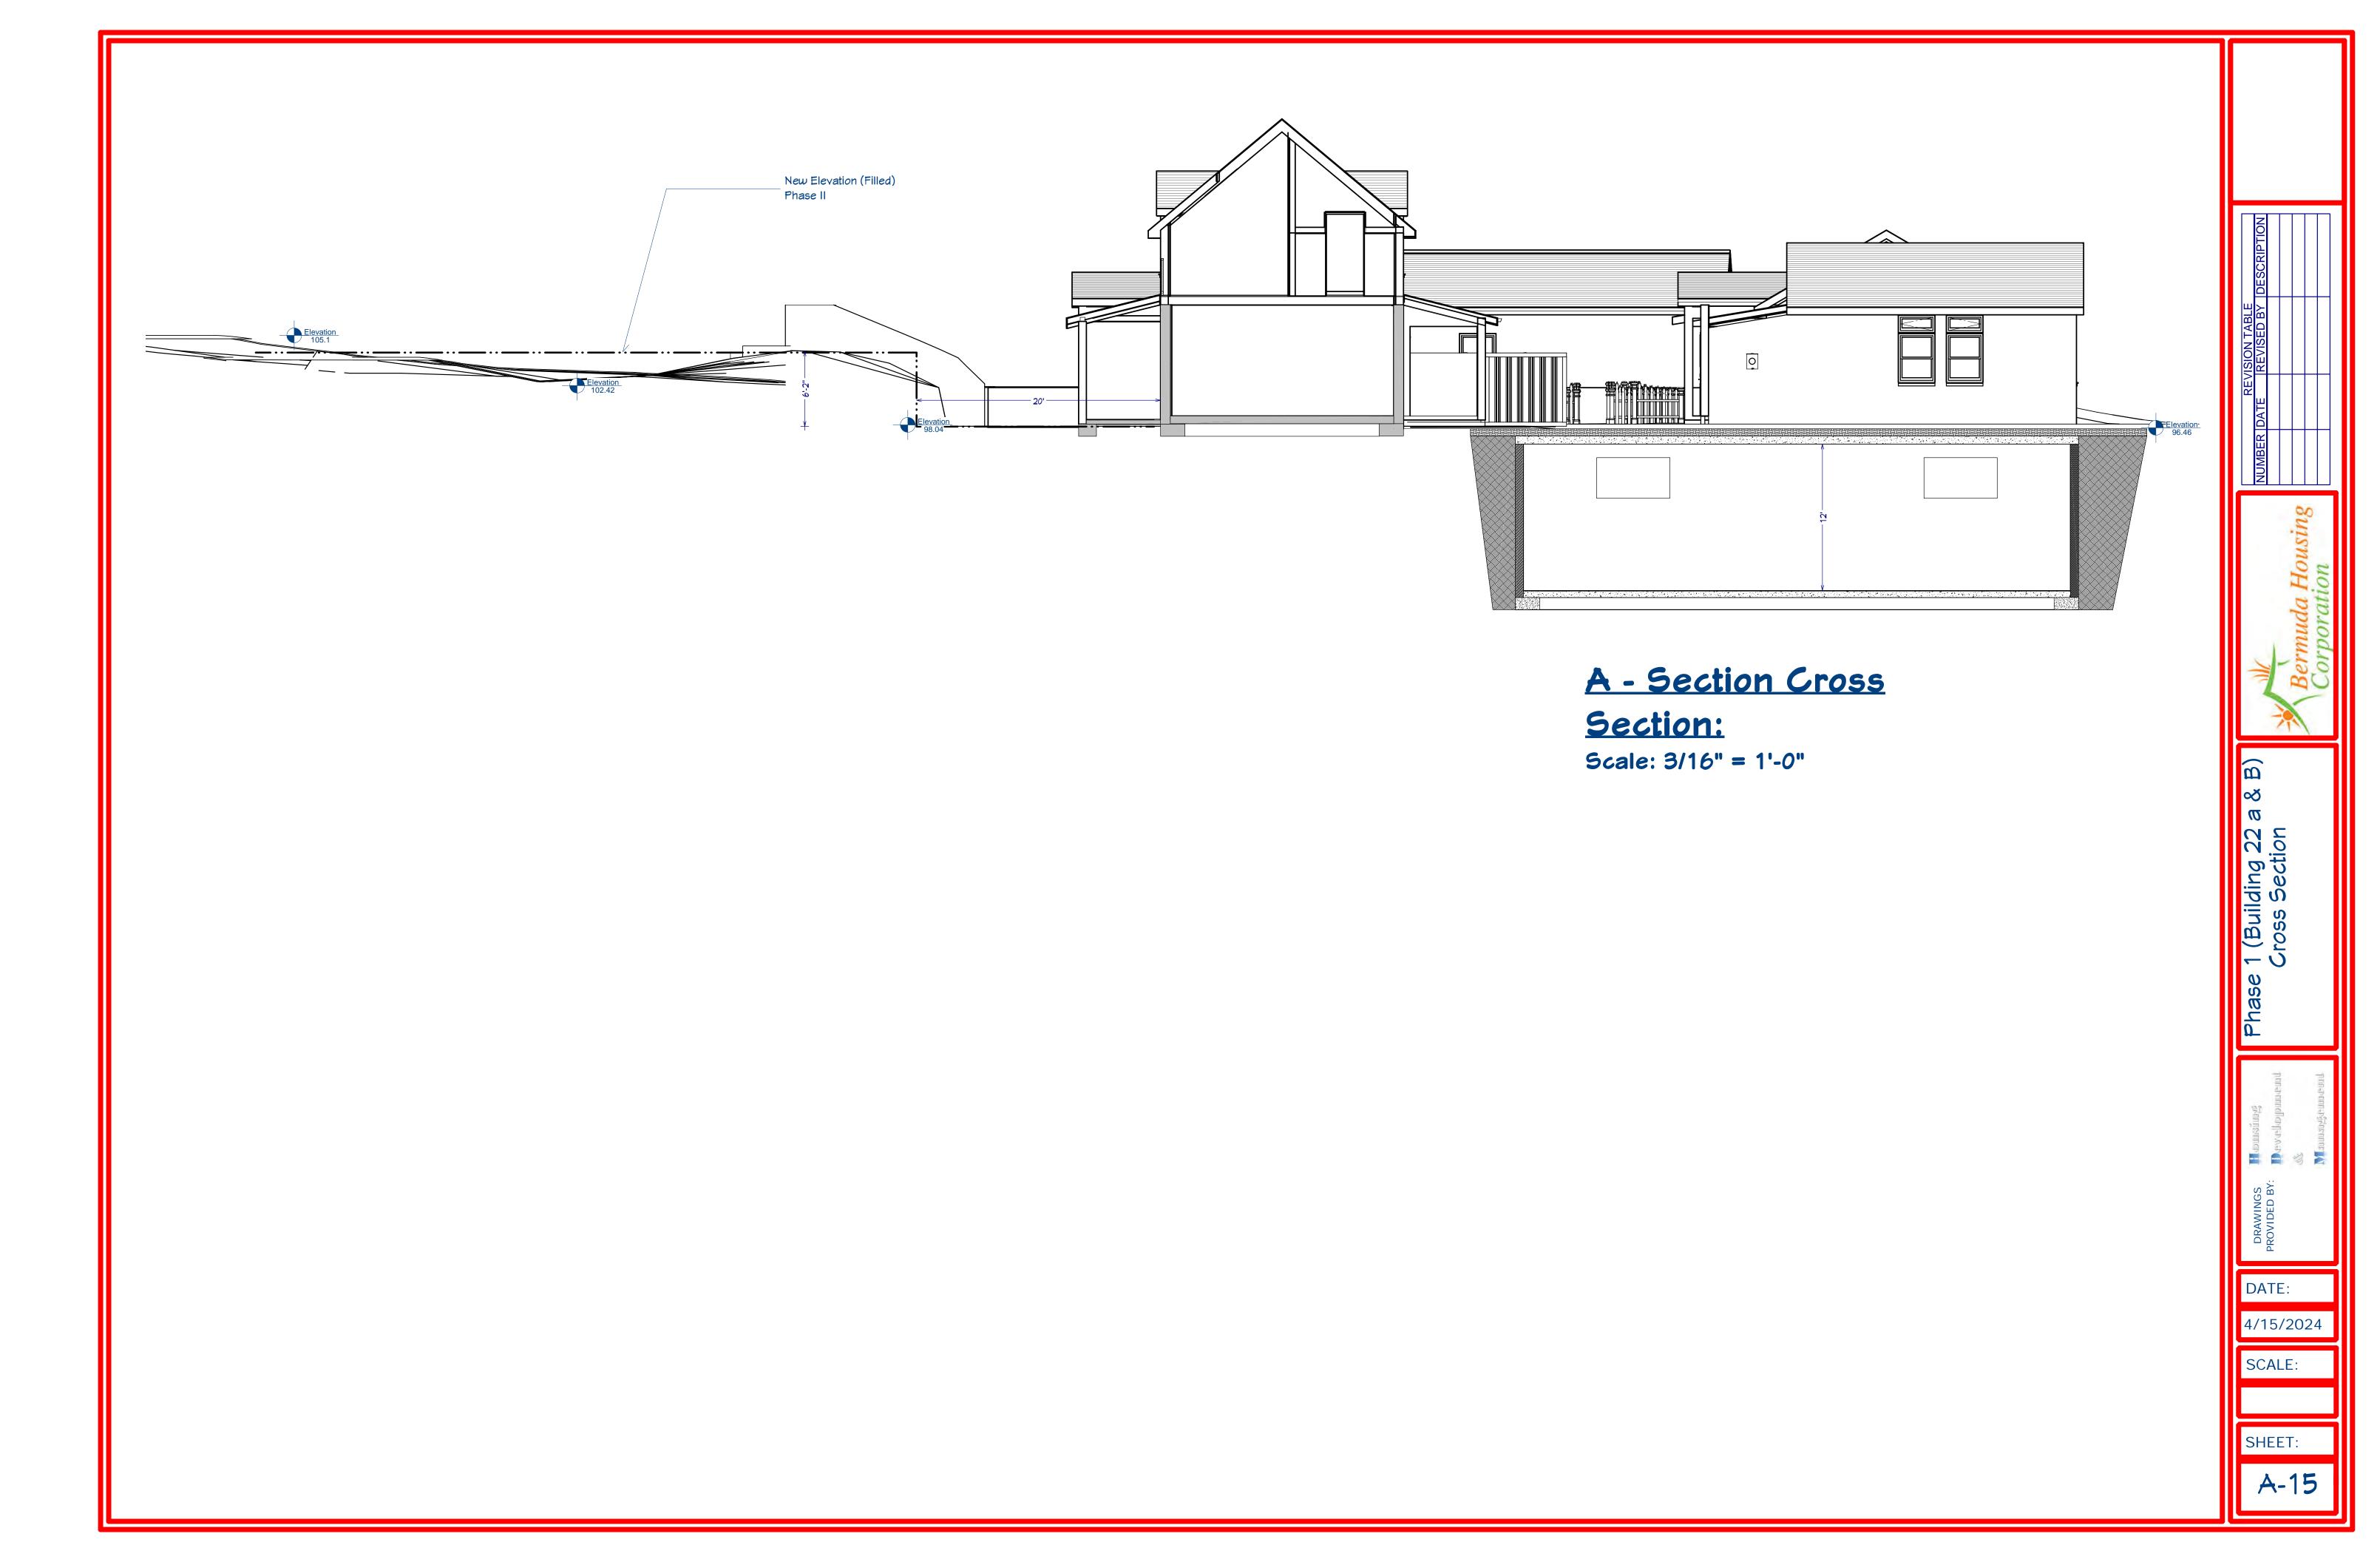

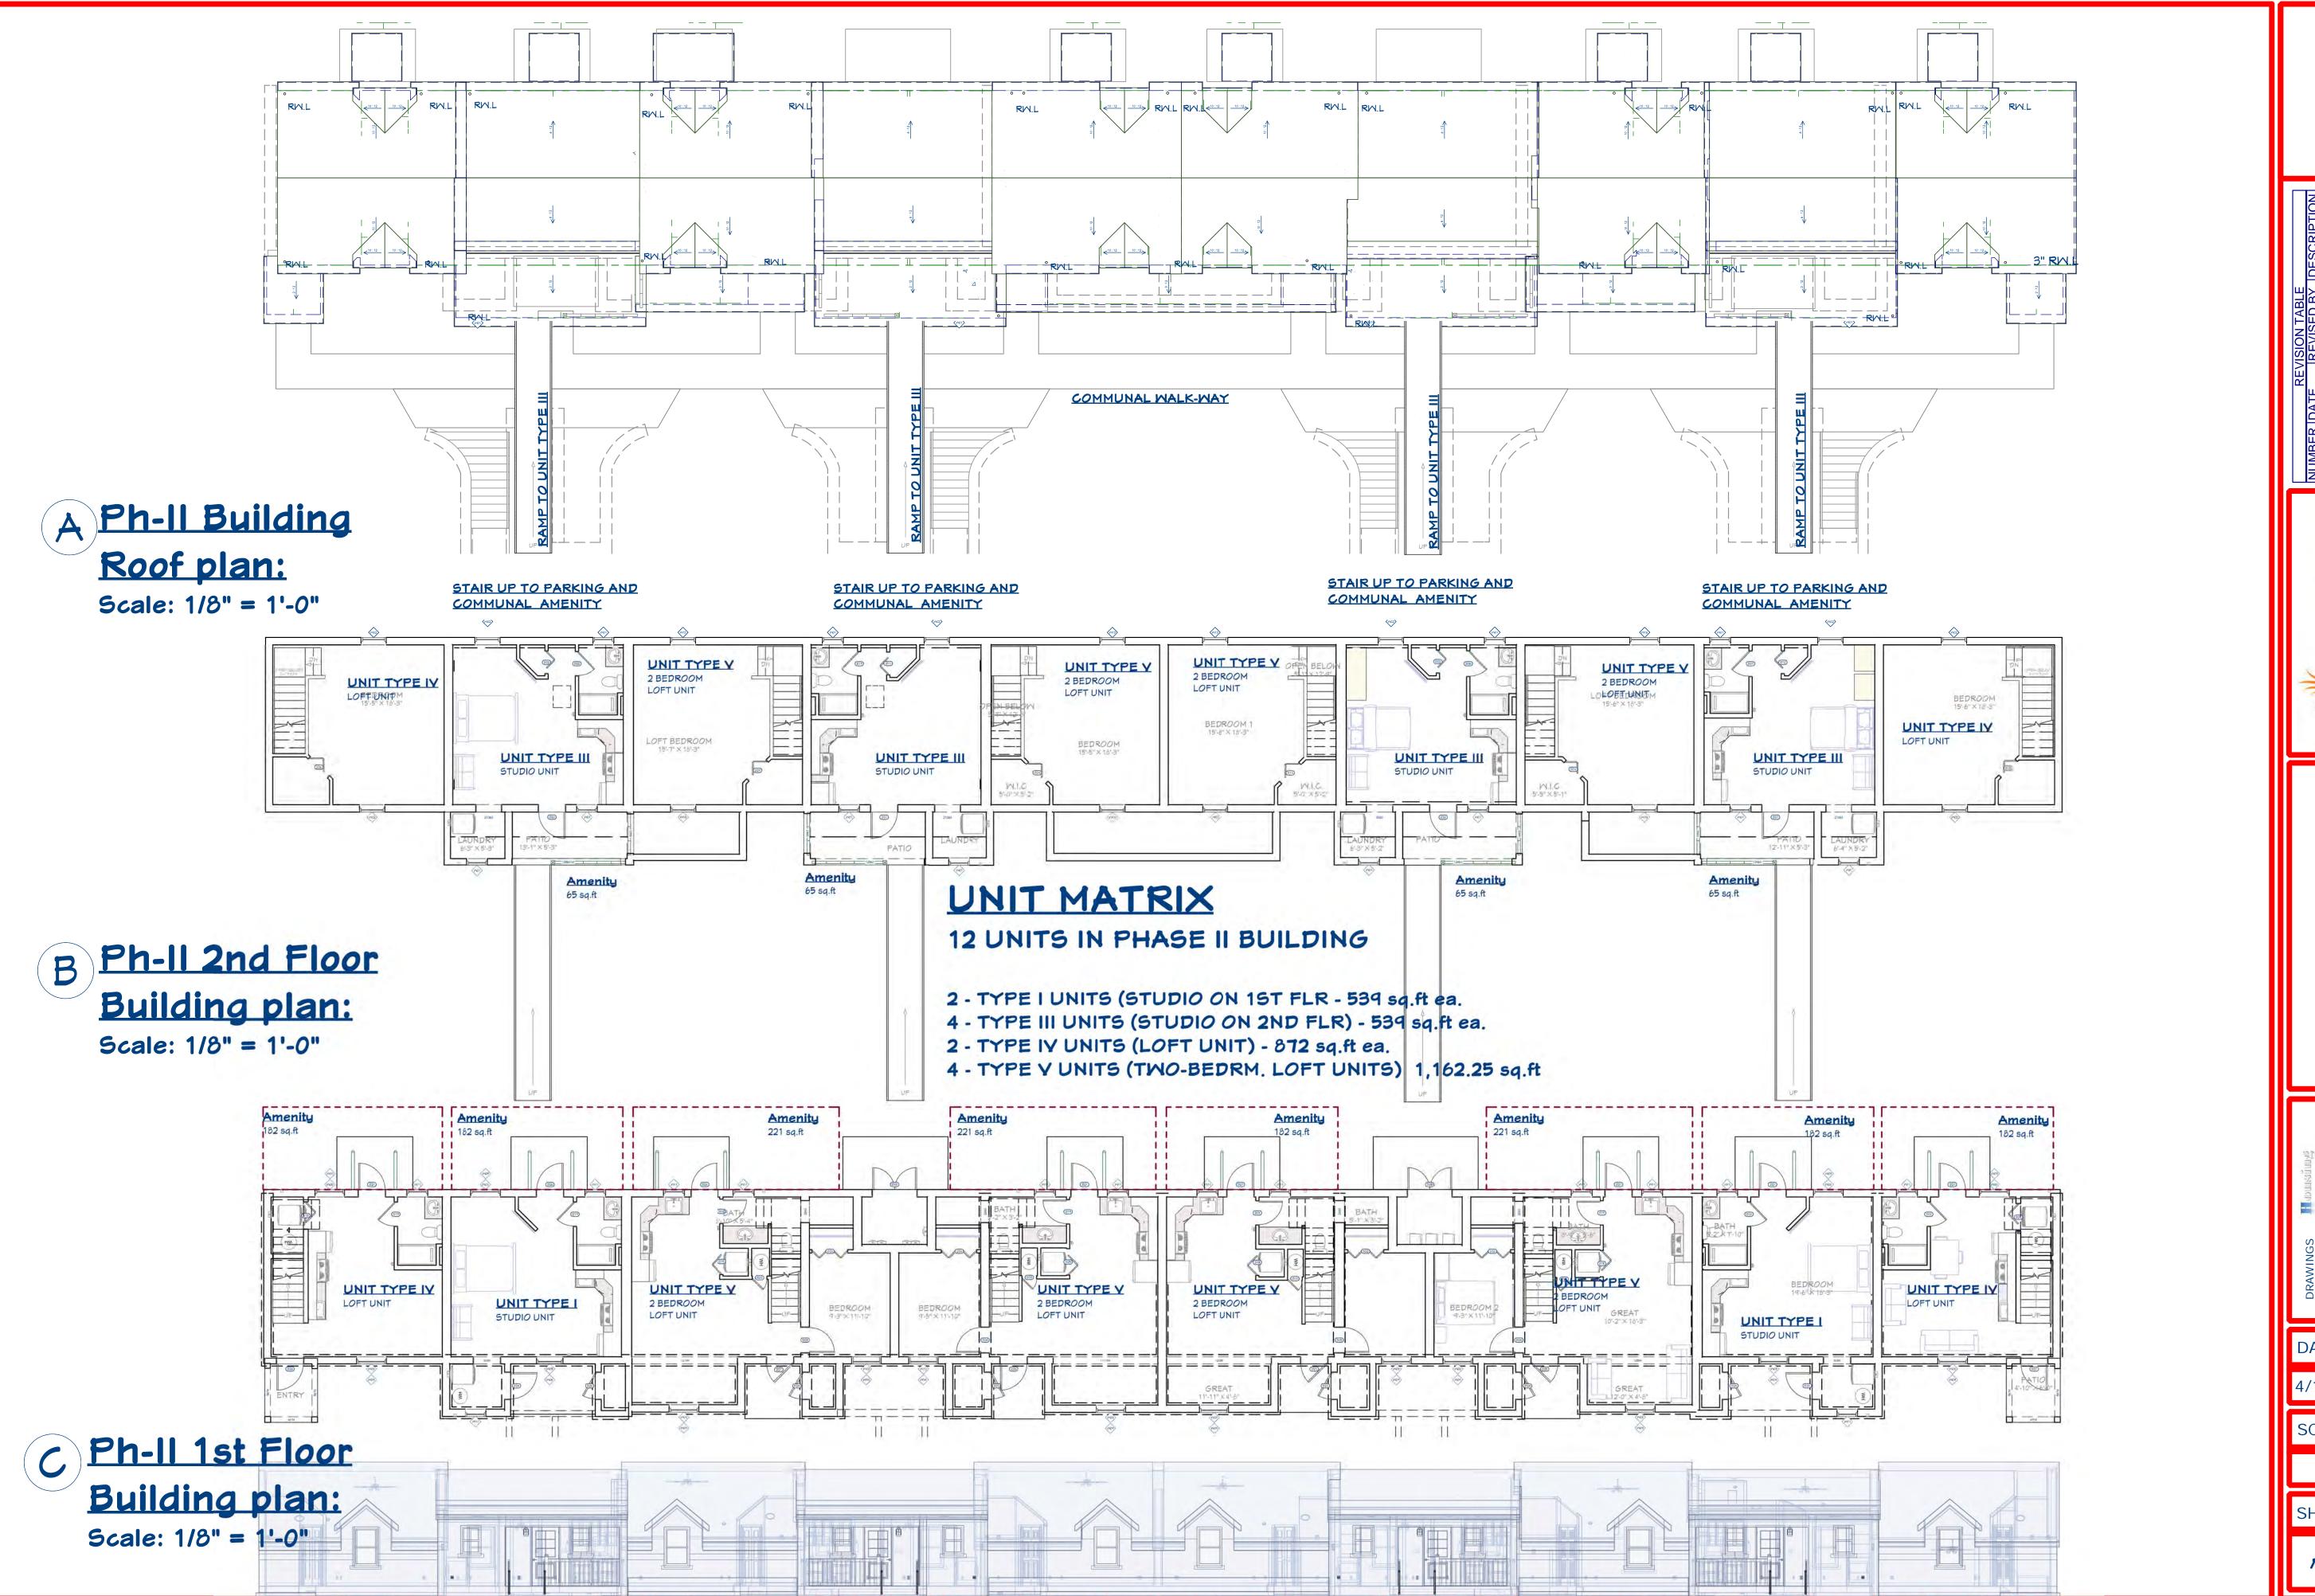

NUMBER DATE REVISED BY DESCRIPTION

Bermuda Hous

Phase II (Building 18) Building Plan unit Matr


MINGS Hapunsinng IDED BY: Develapproneurl


DATE:

4/15/2024

SCALE:

SHEET:

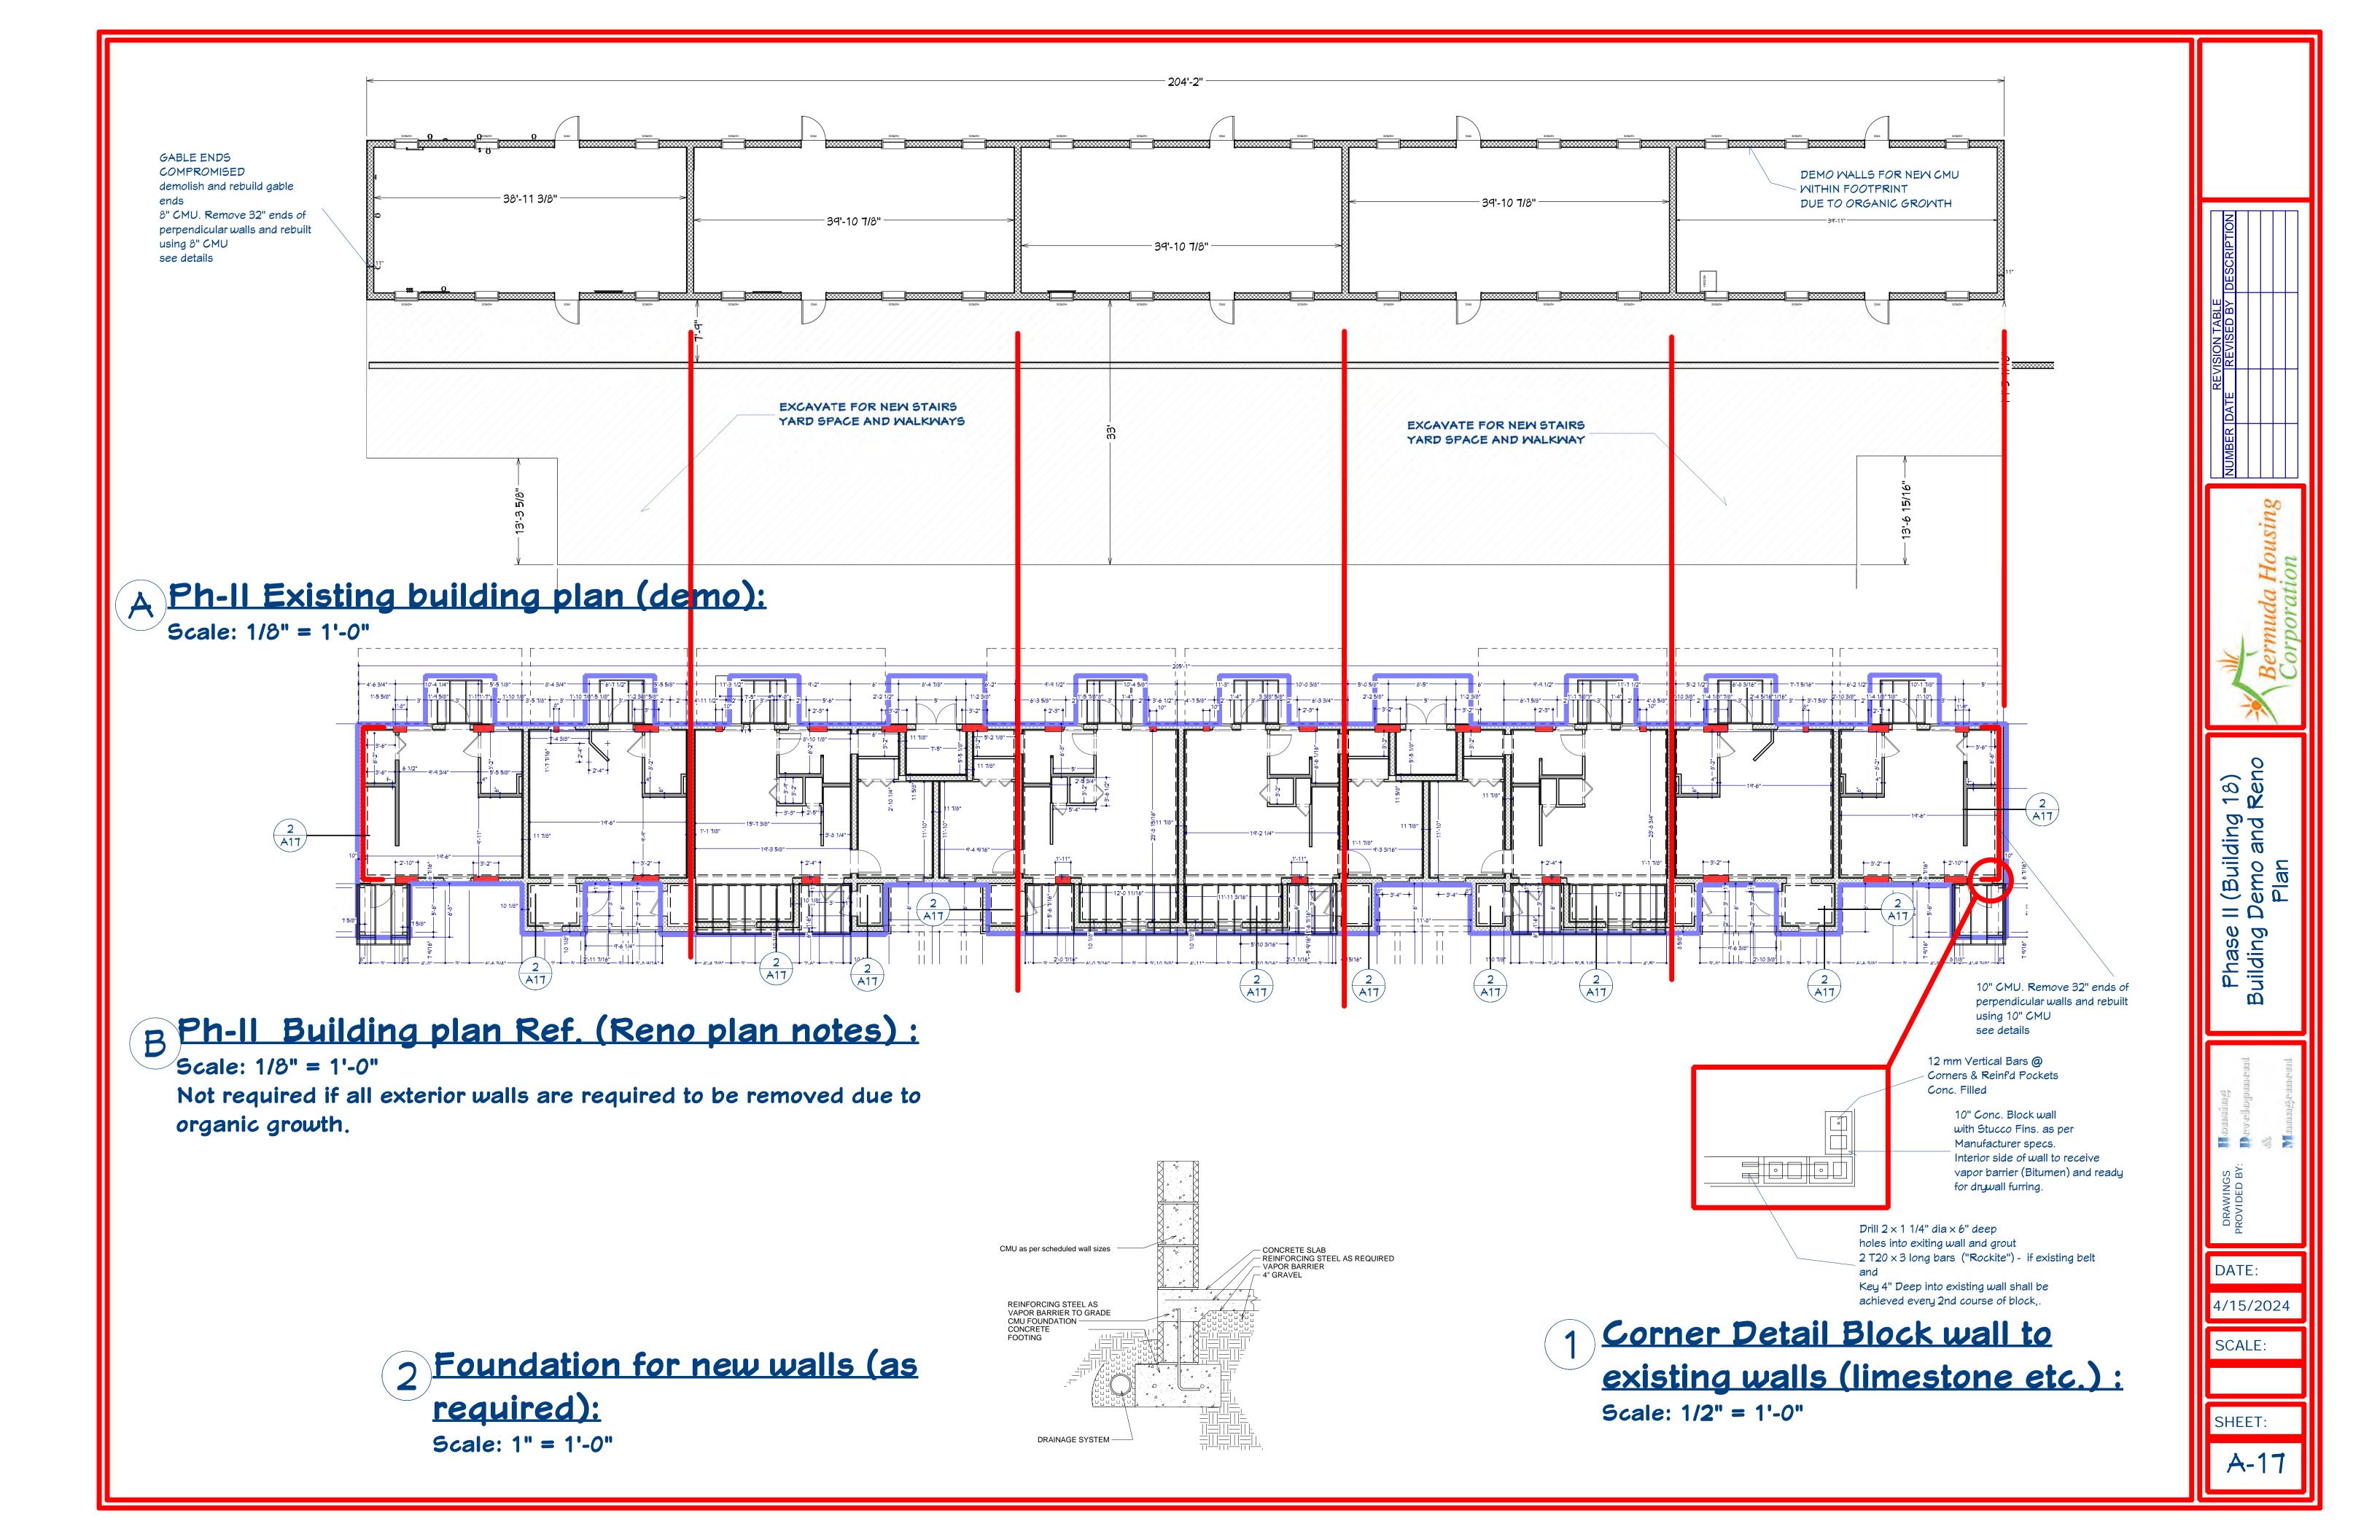

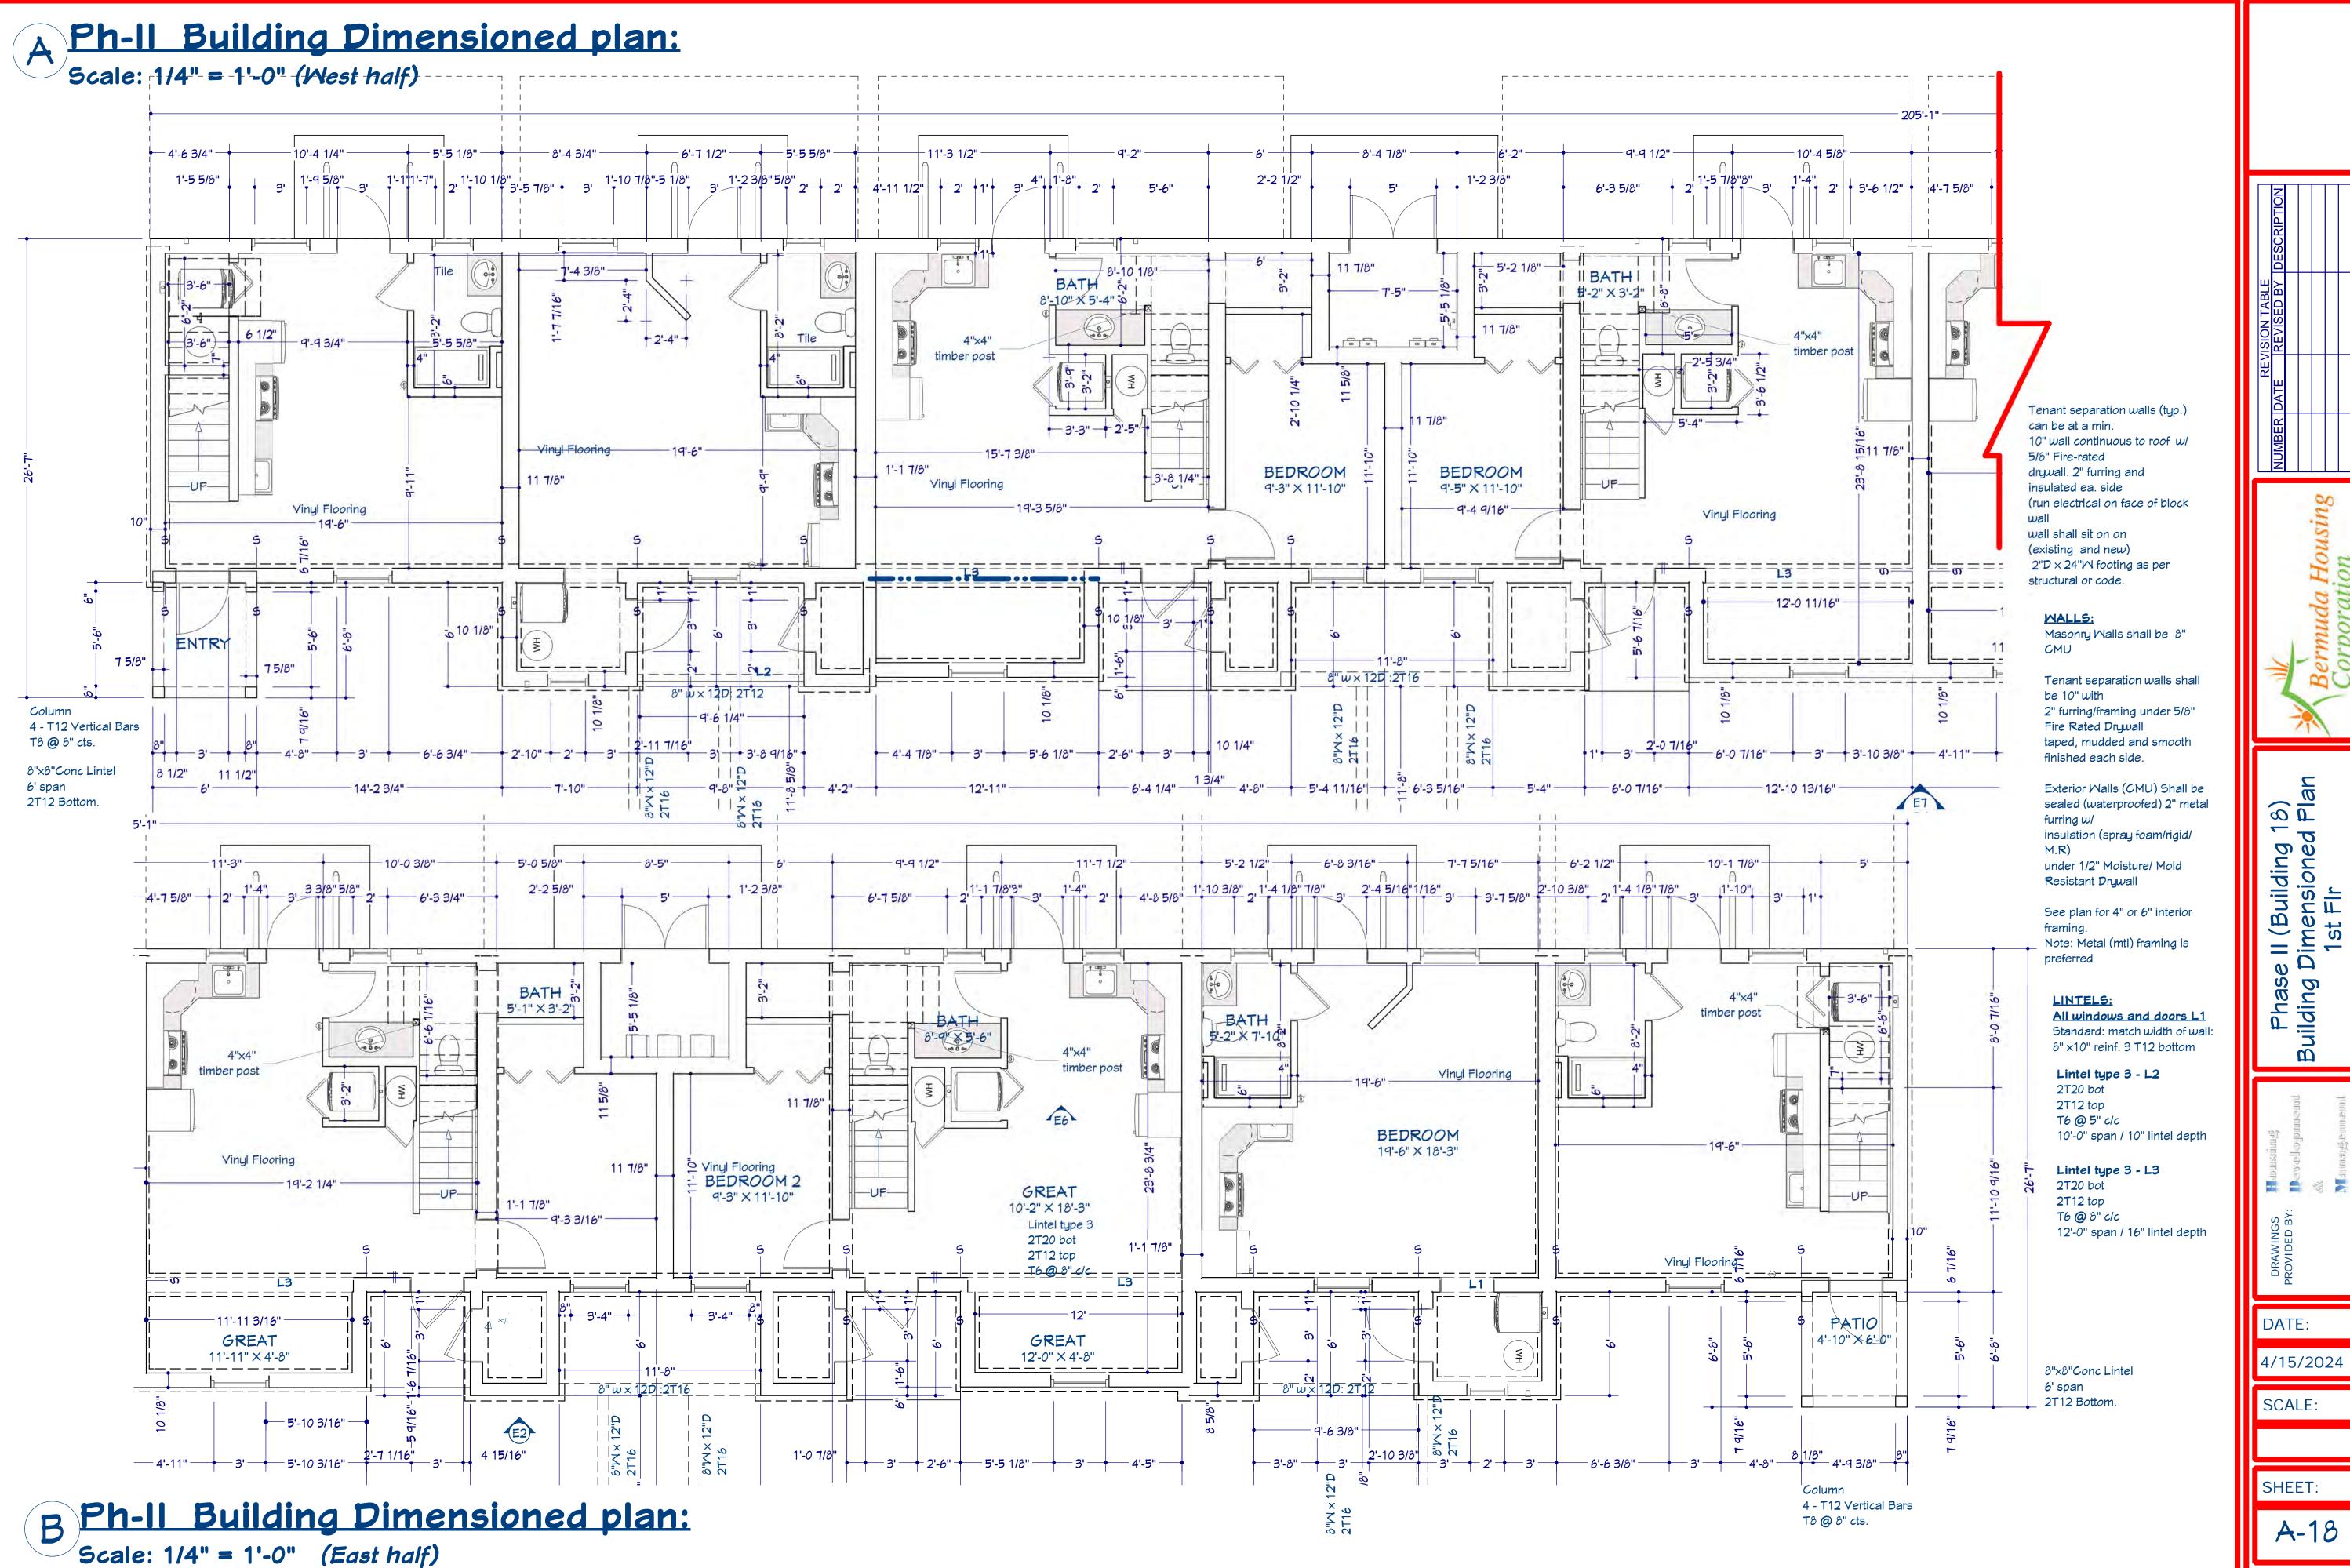


 \widehat{a}

Phase suilding D

4/15/2024

SCALE:

SHEET:

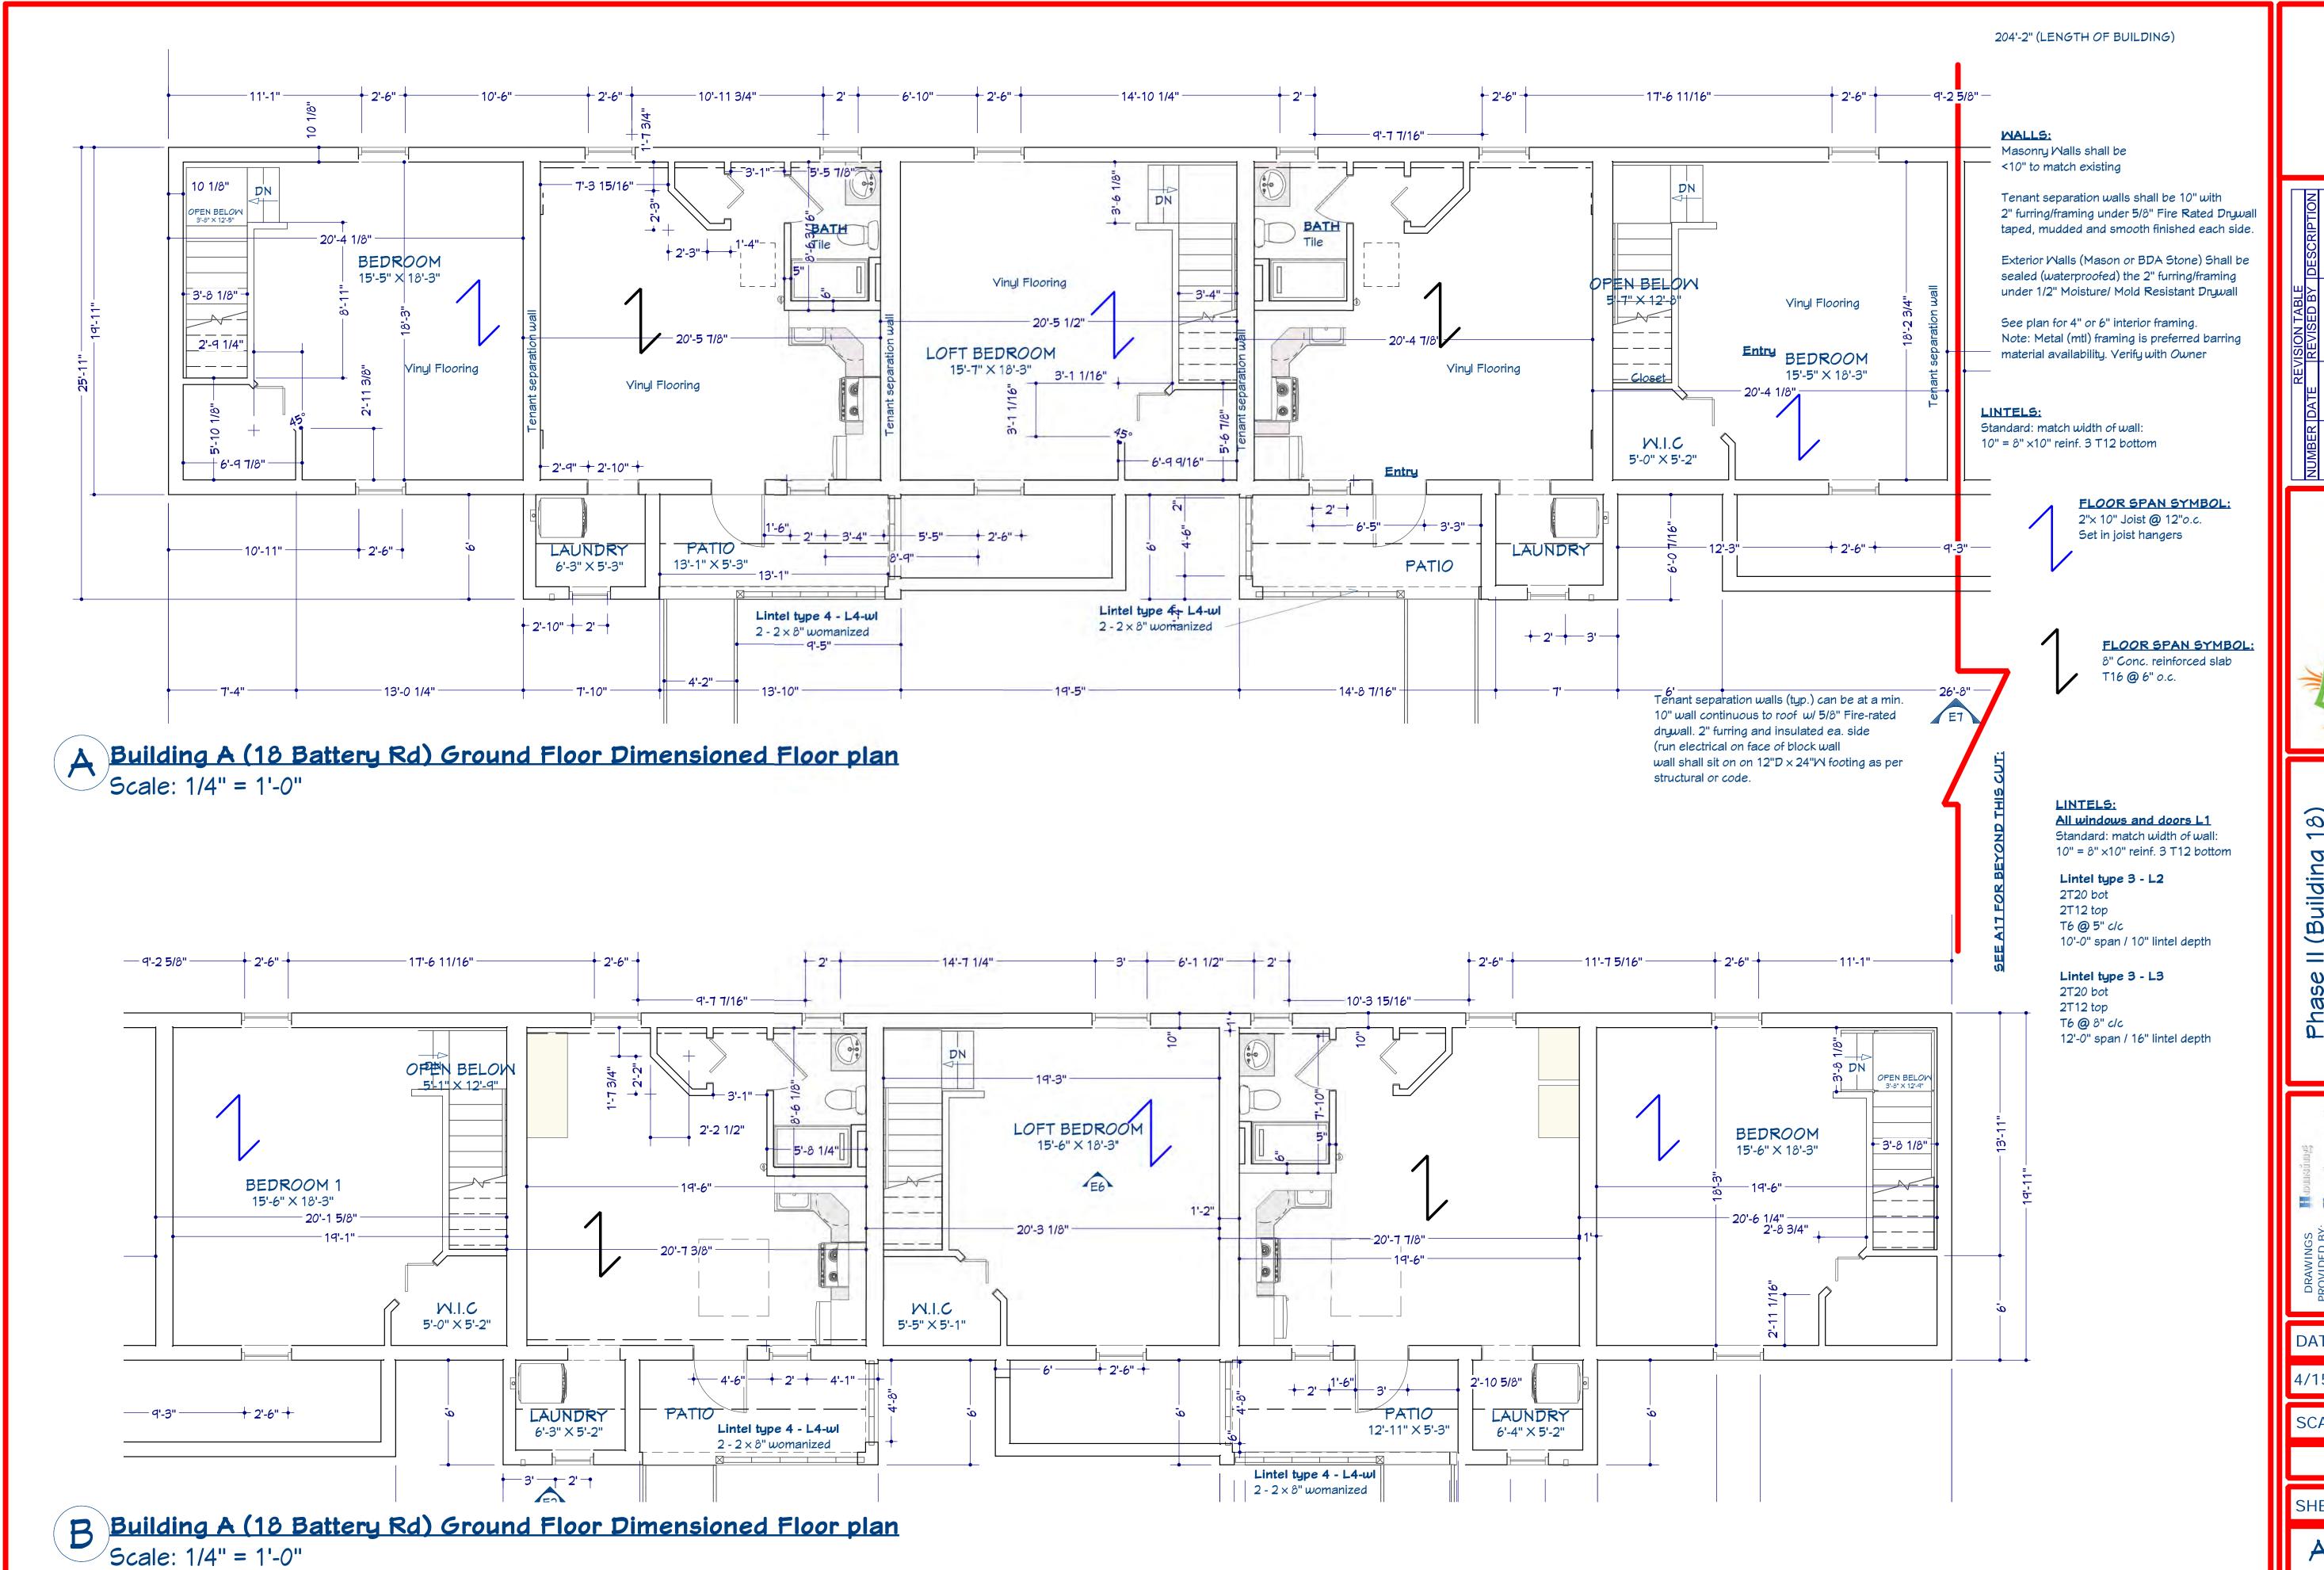

 \widehat{a} Phase II (Building 1 Building Dimensioned 2nd FIr


sing


DATE:

4/15/2024


SCALE:


SHEET:

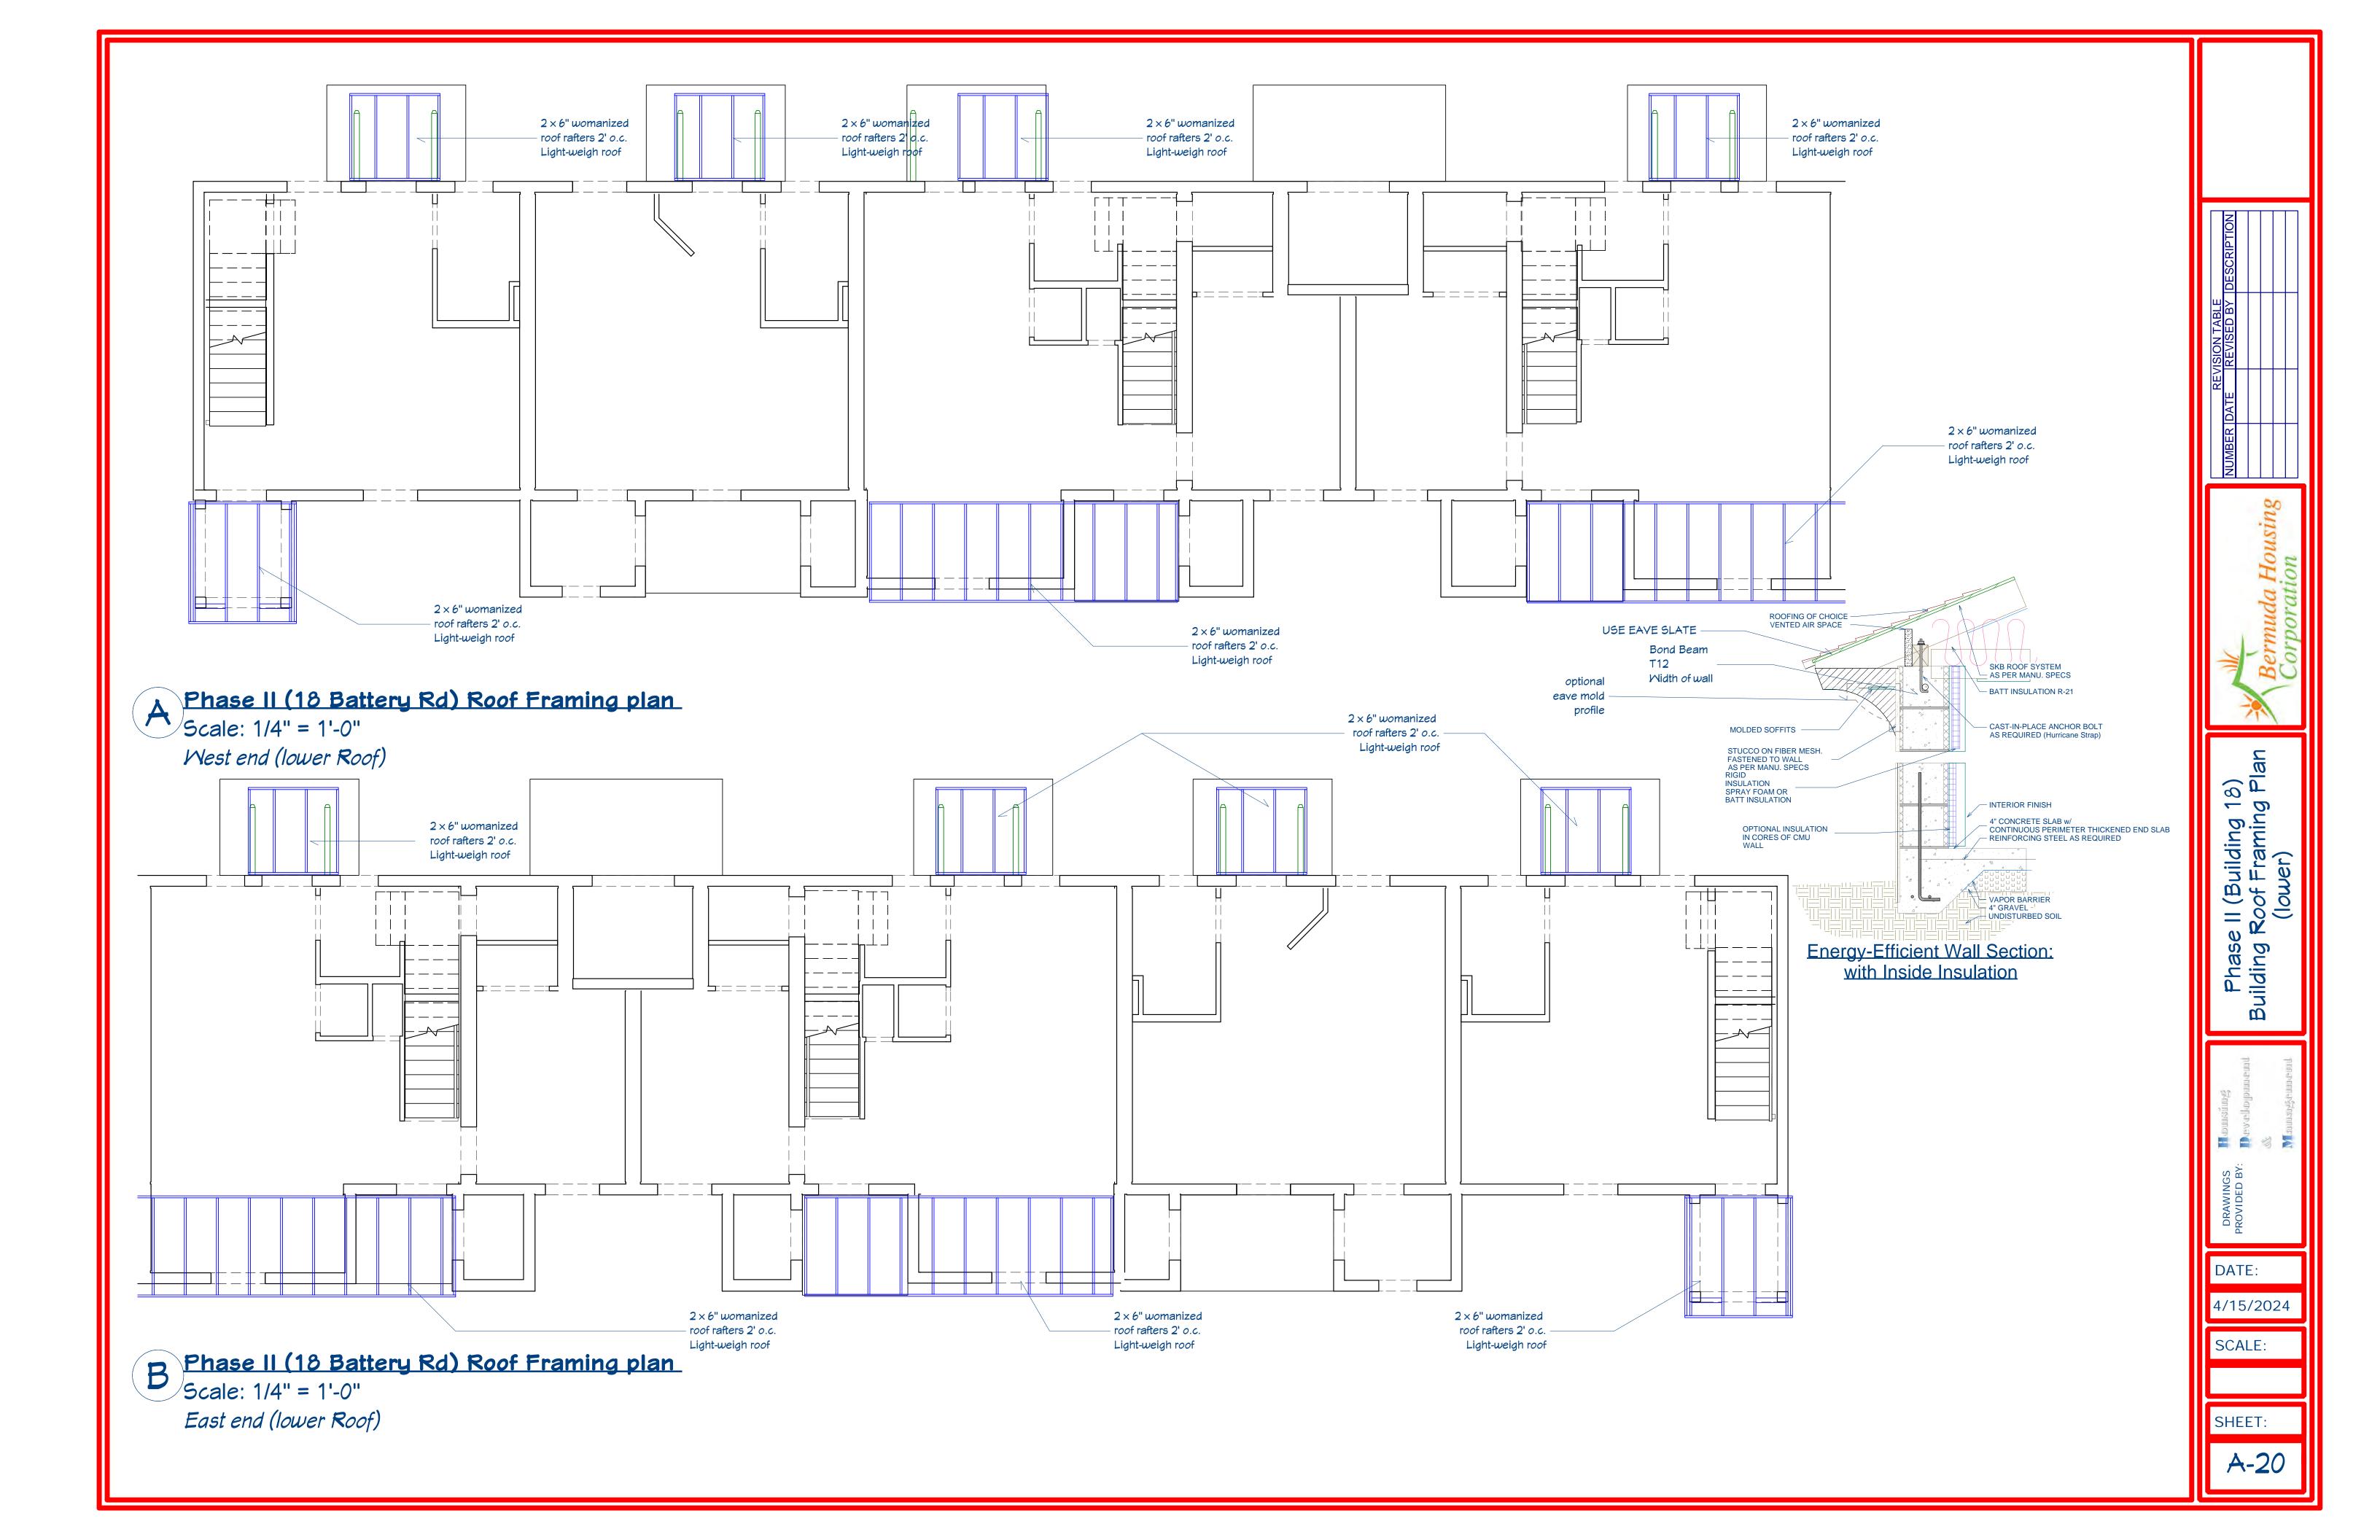

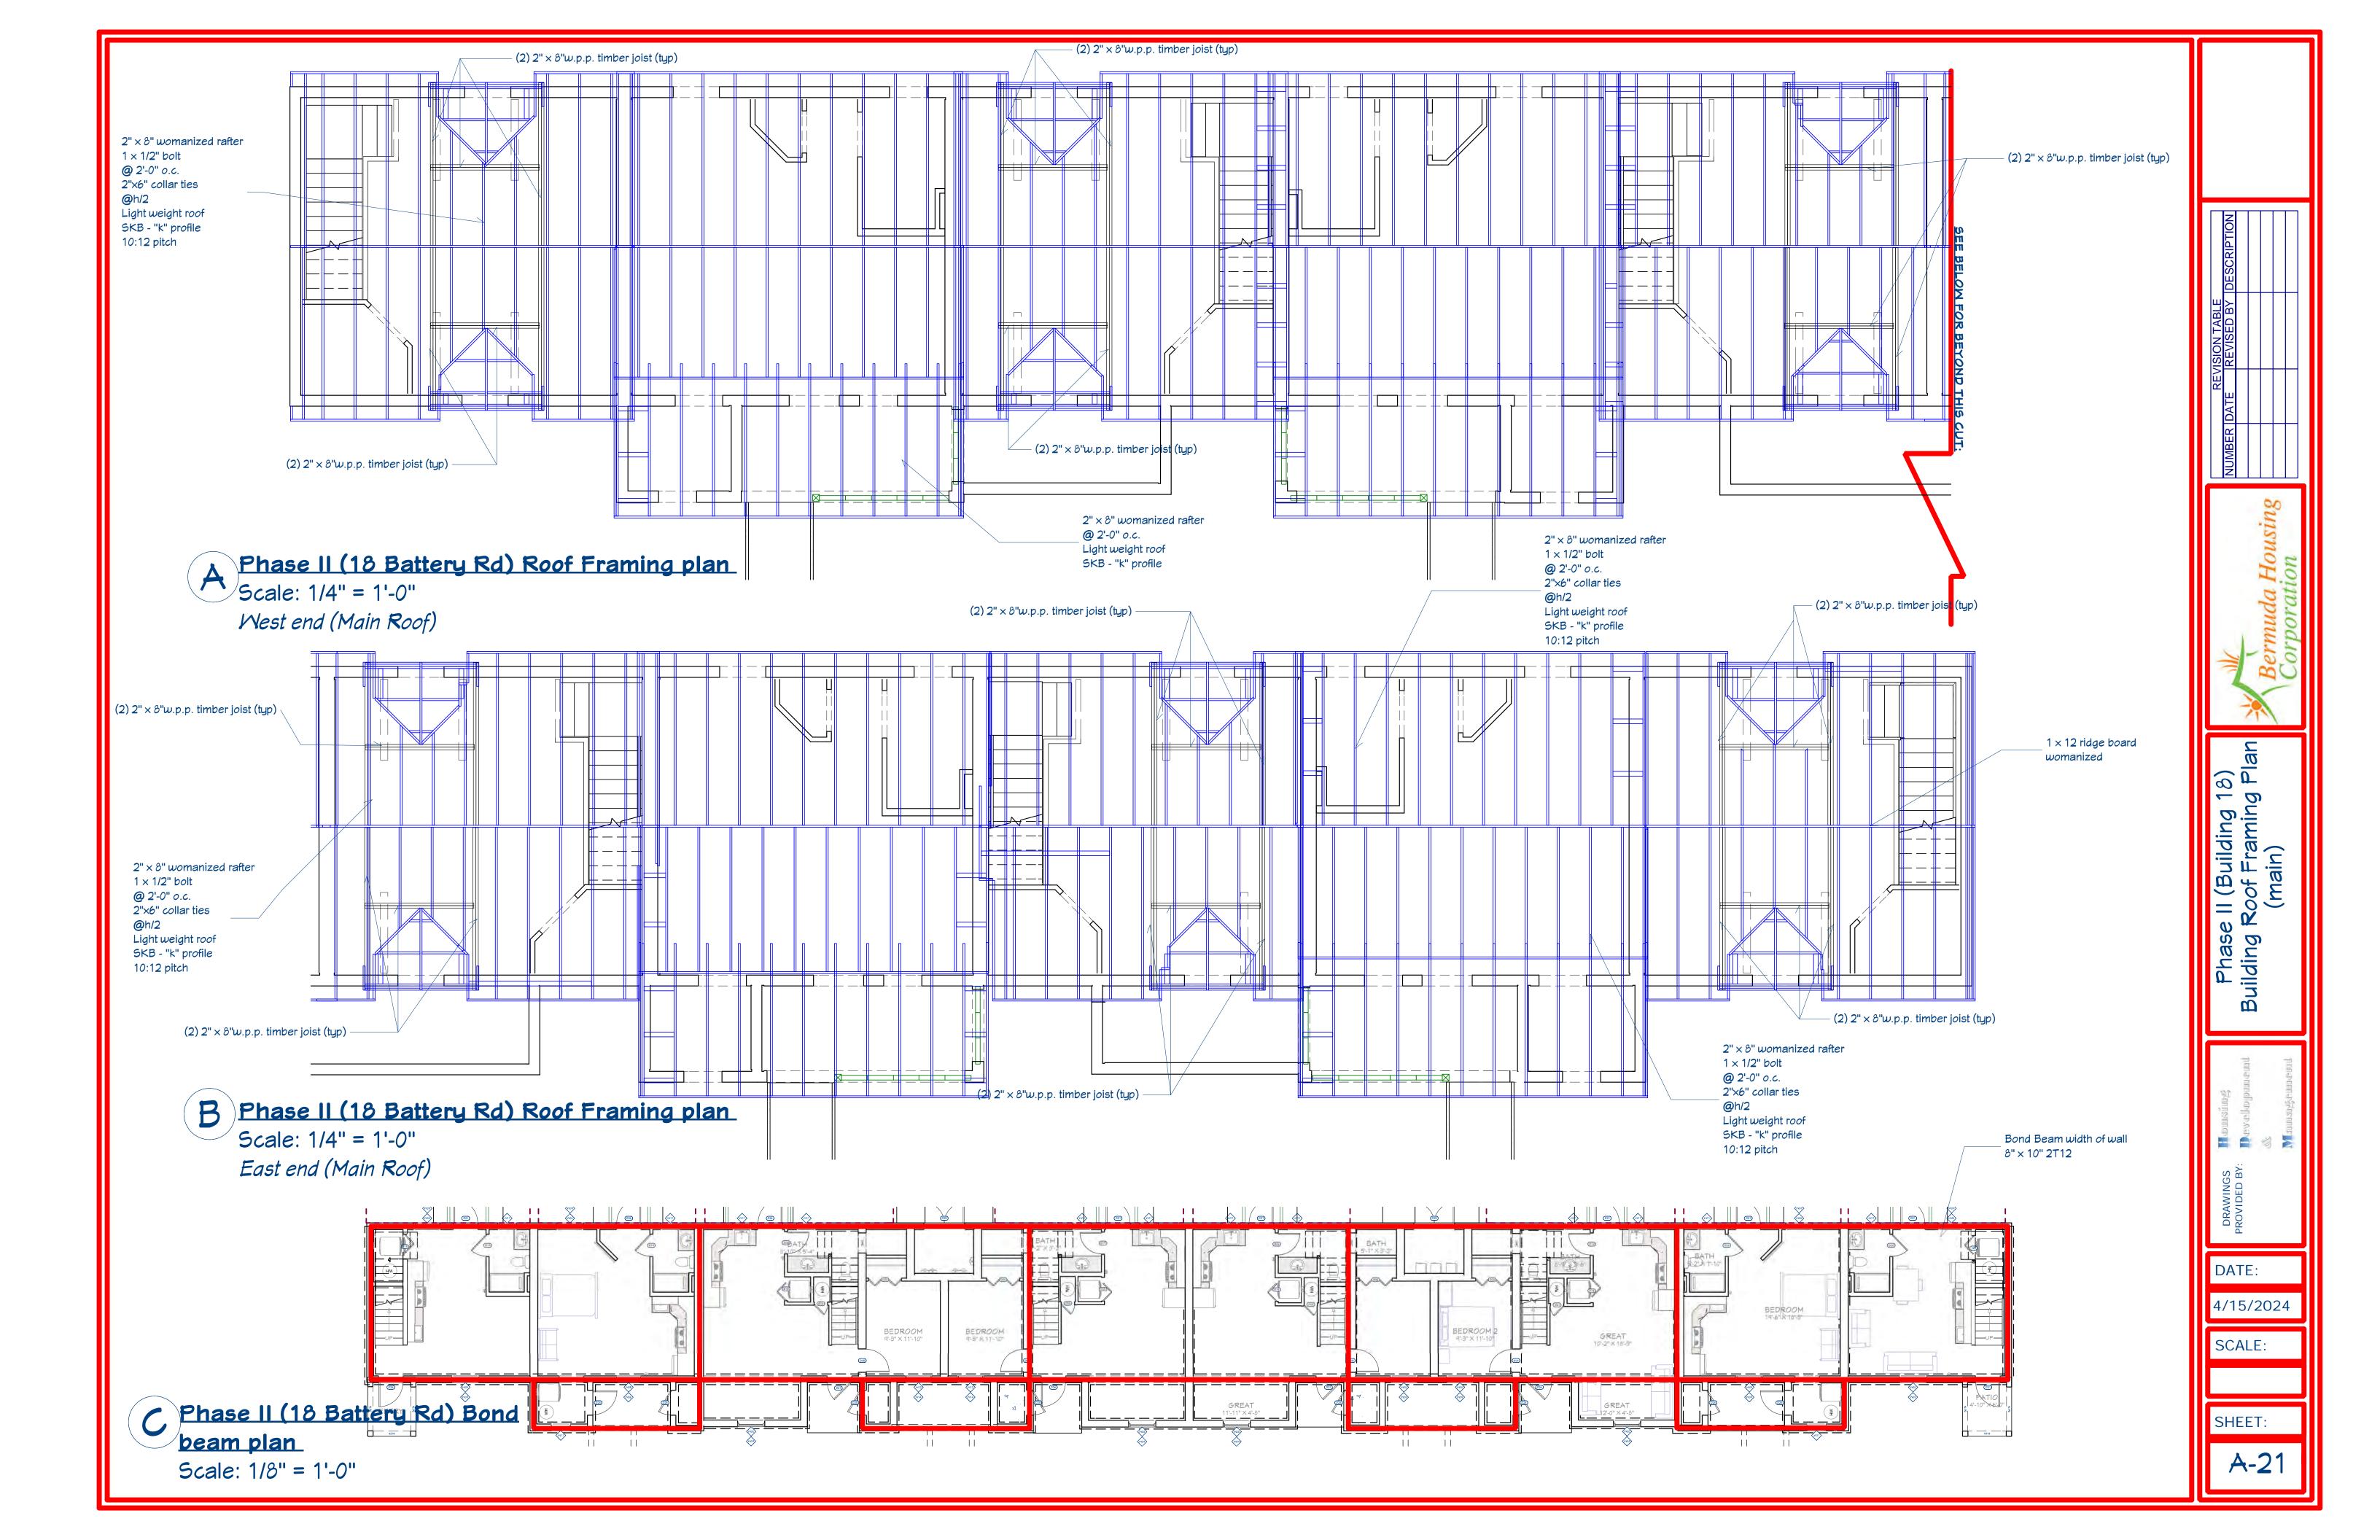



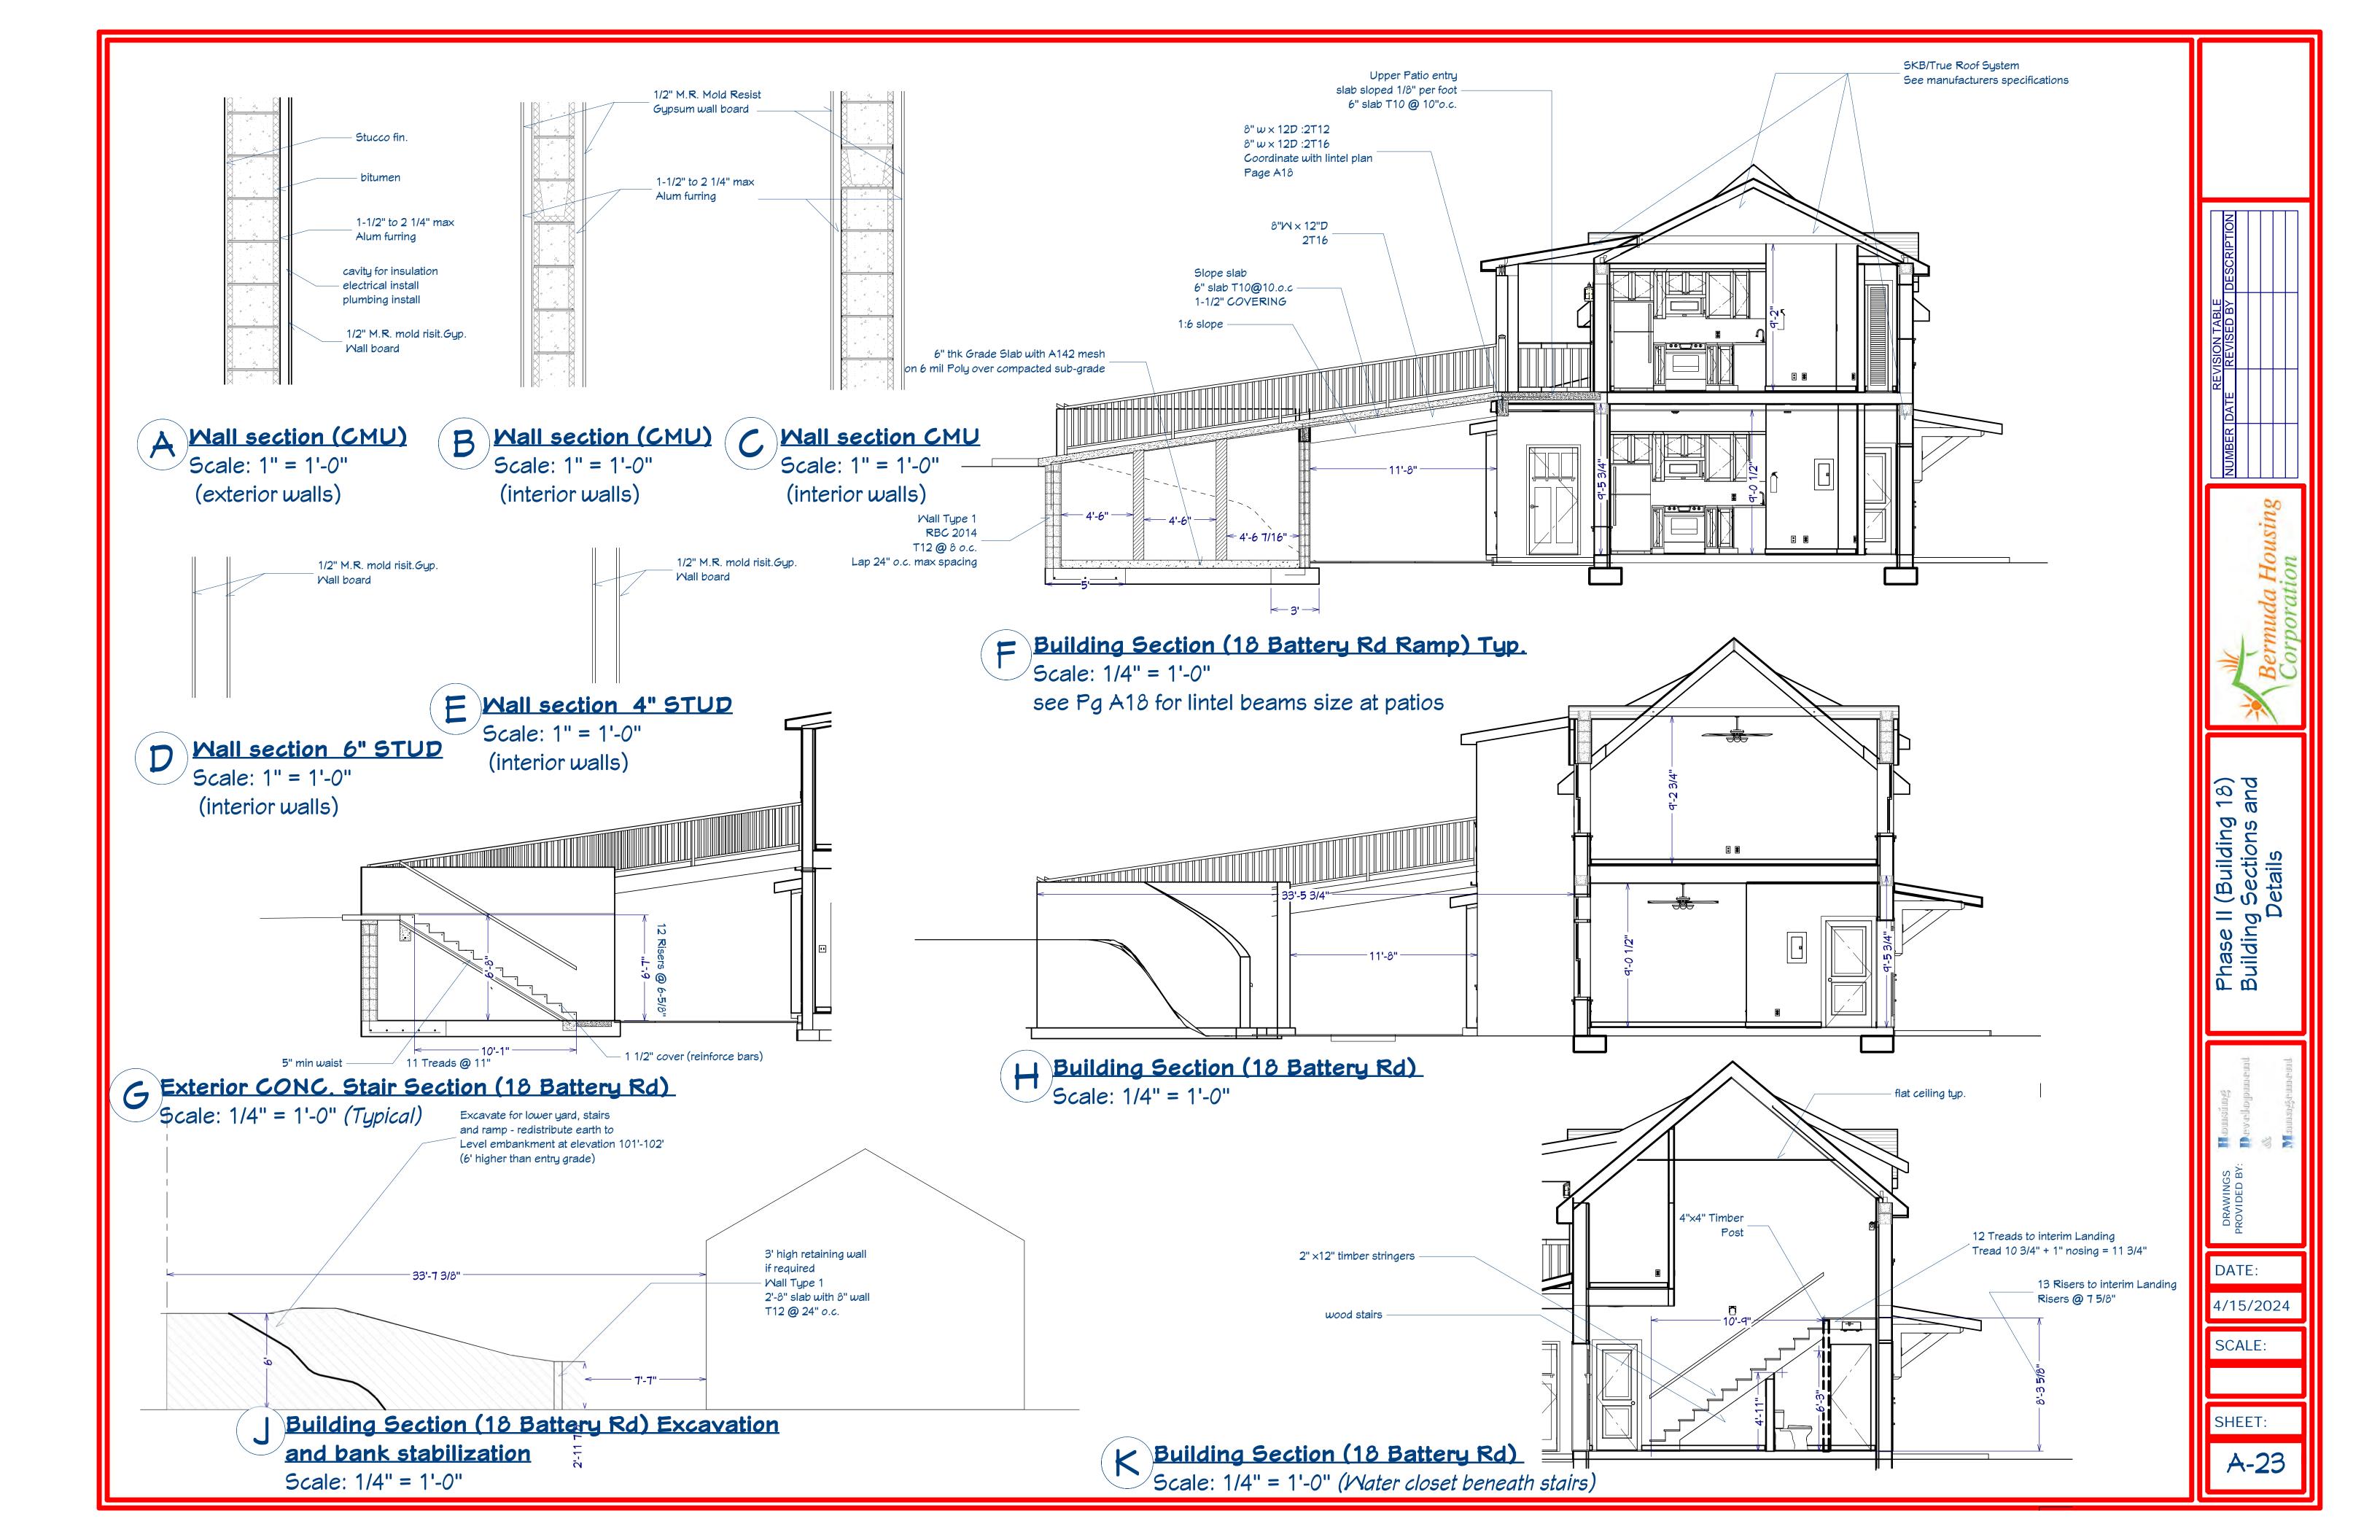

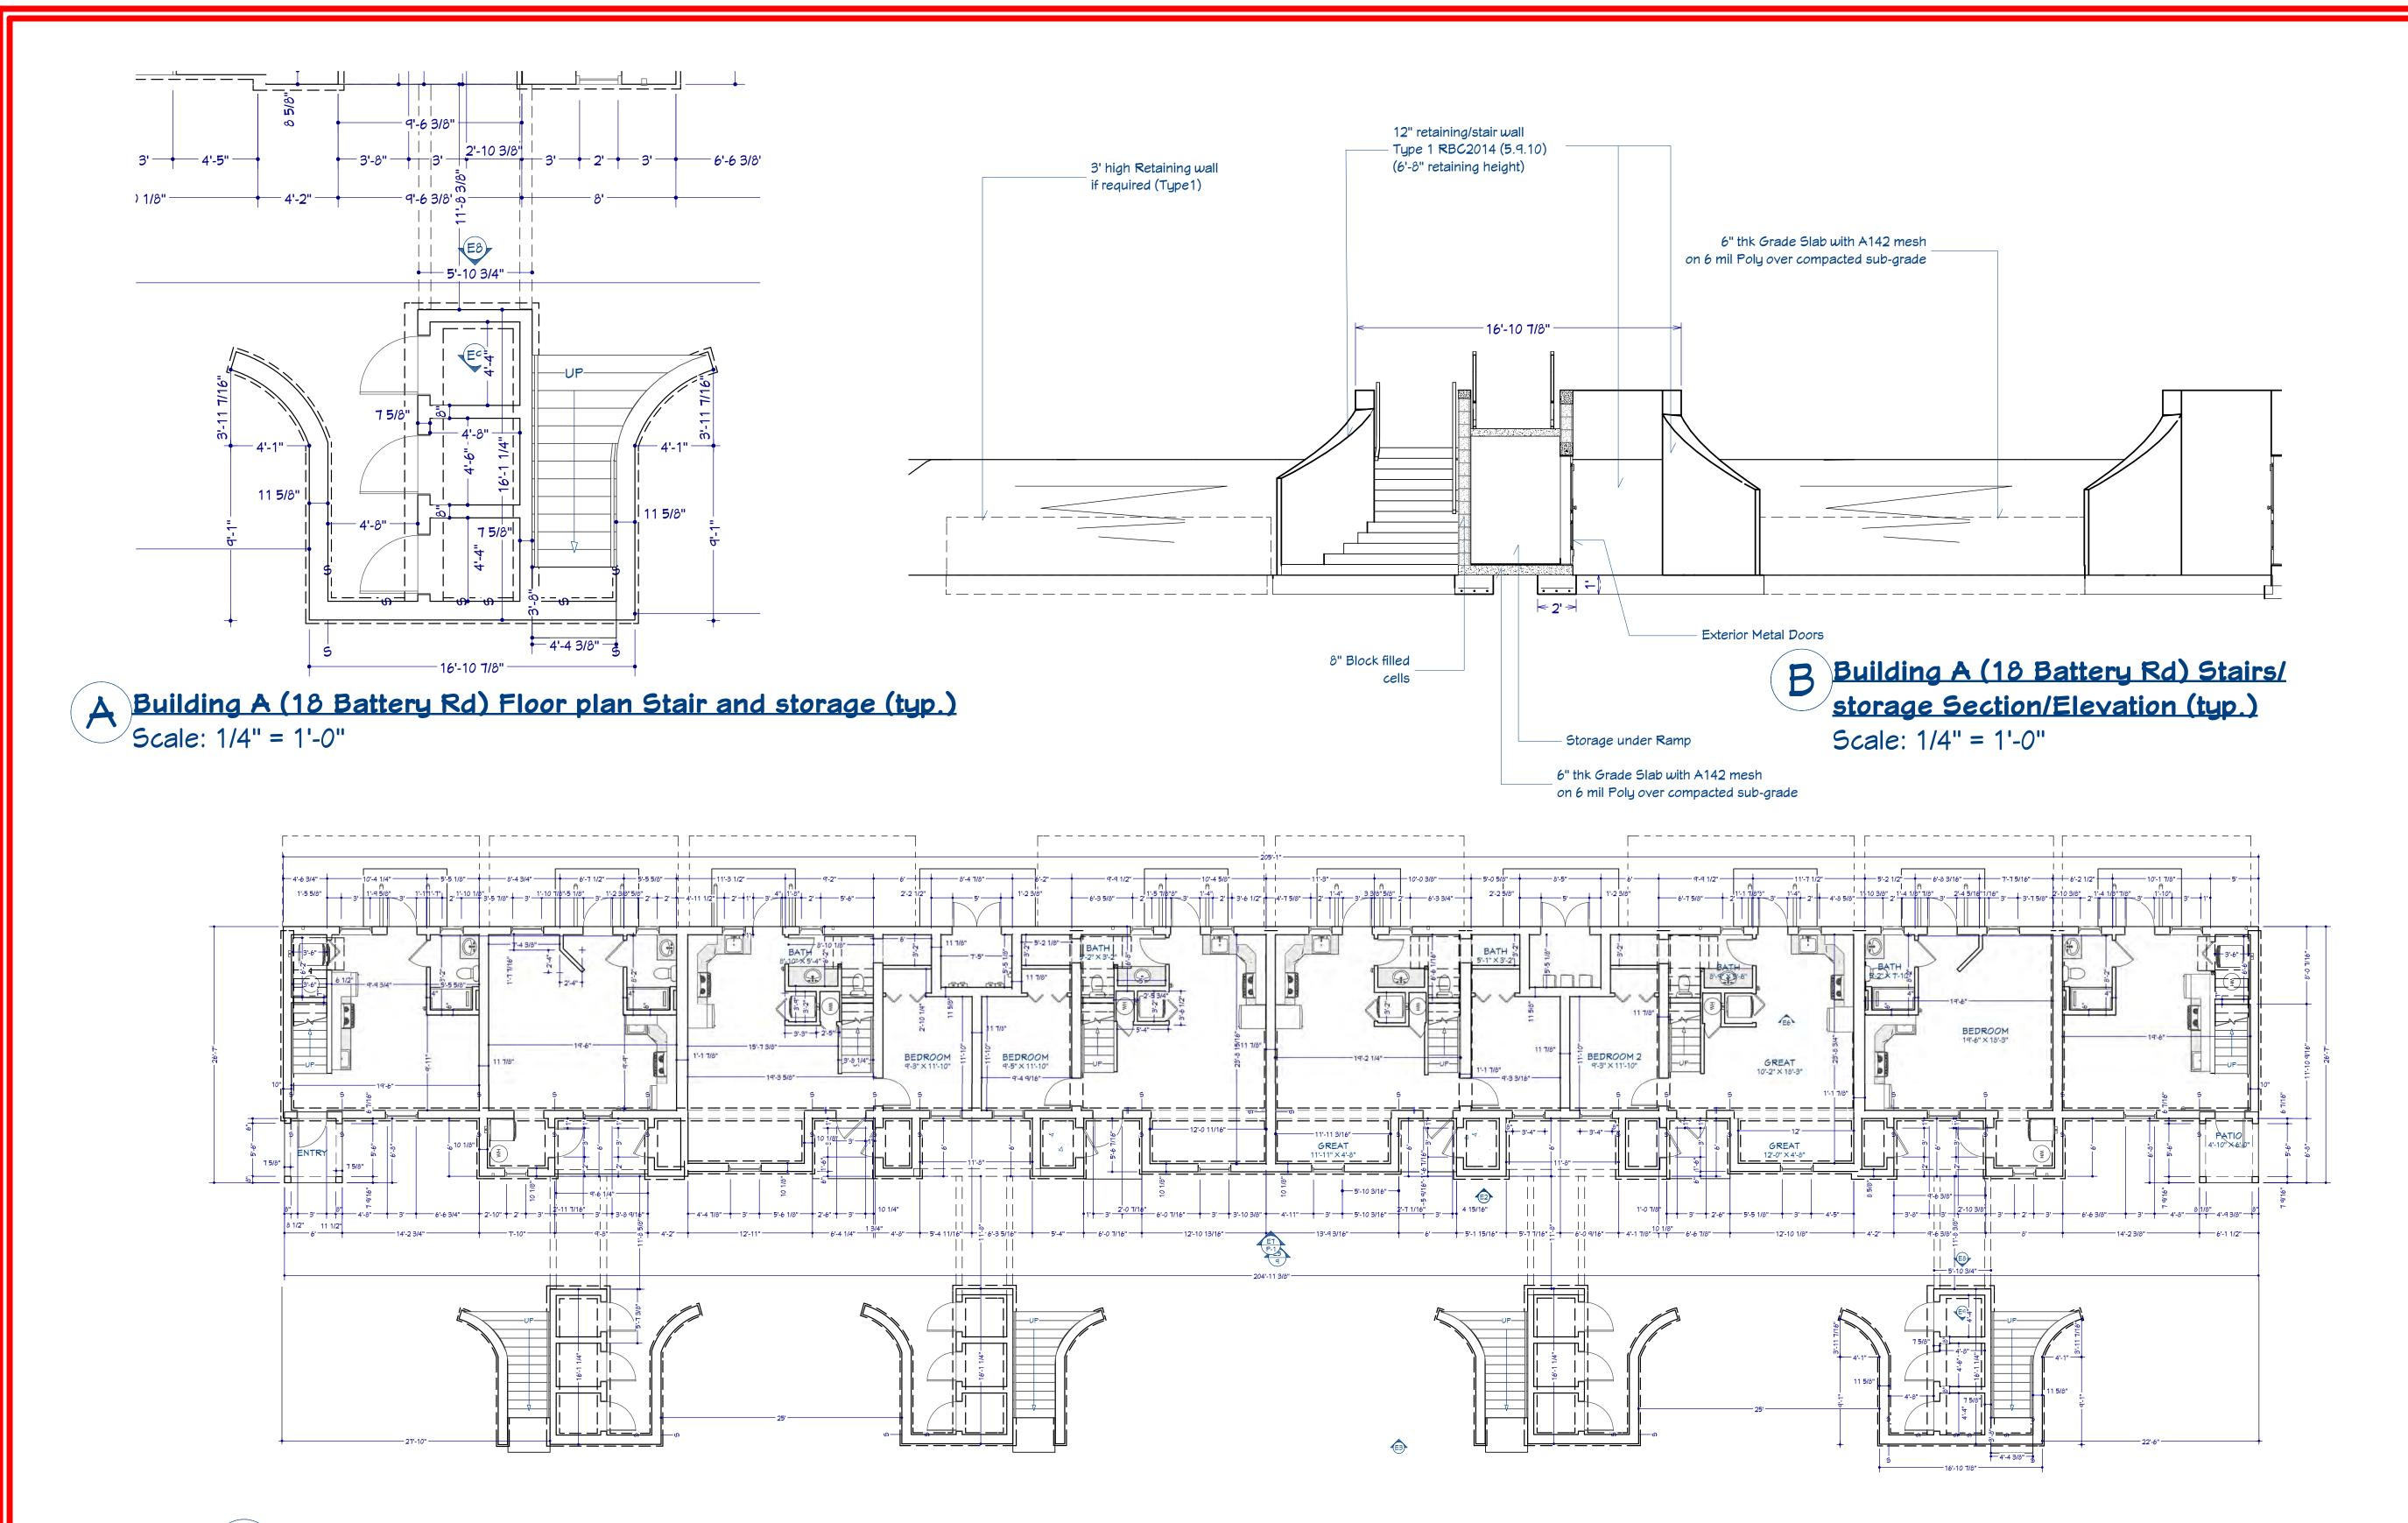

B Building A (18 Battery Rd) Exterior Stair Reference plan Scale: 1/4" = 1'-0"

Phase II (Building ' Building Sections a Details

DATE:

4/15/2024

SCALE:

SHEET:



NUMBER DATE REVISED BY DESCRIPTION

Bermuda Housin Corporation

Phase II (Building 18)

IDED BY: Develleppumend

DATE:

4/15/2024

SCALE:

SHEET:



MINGS Habuusiinugg DED BY: Devellappannennd


ase II (Bu ectrical 2

DATE:


4/15/2024


SCALE:


SHEET:

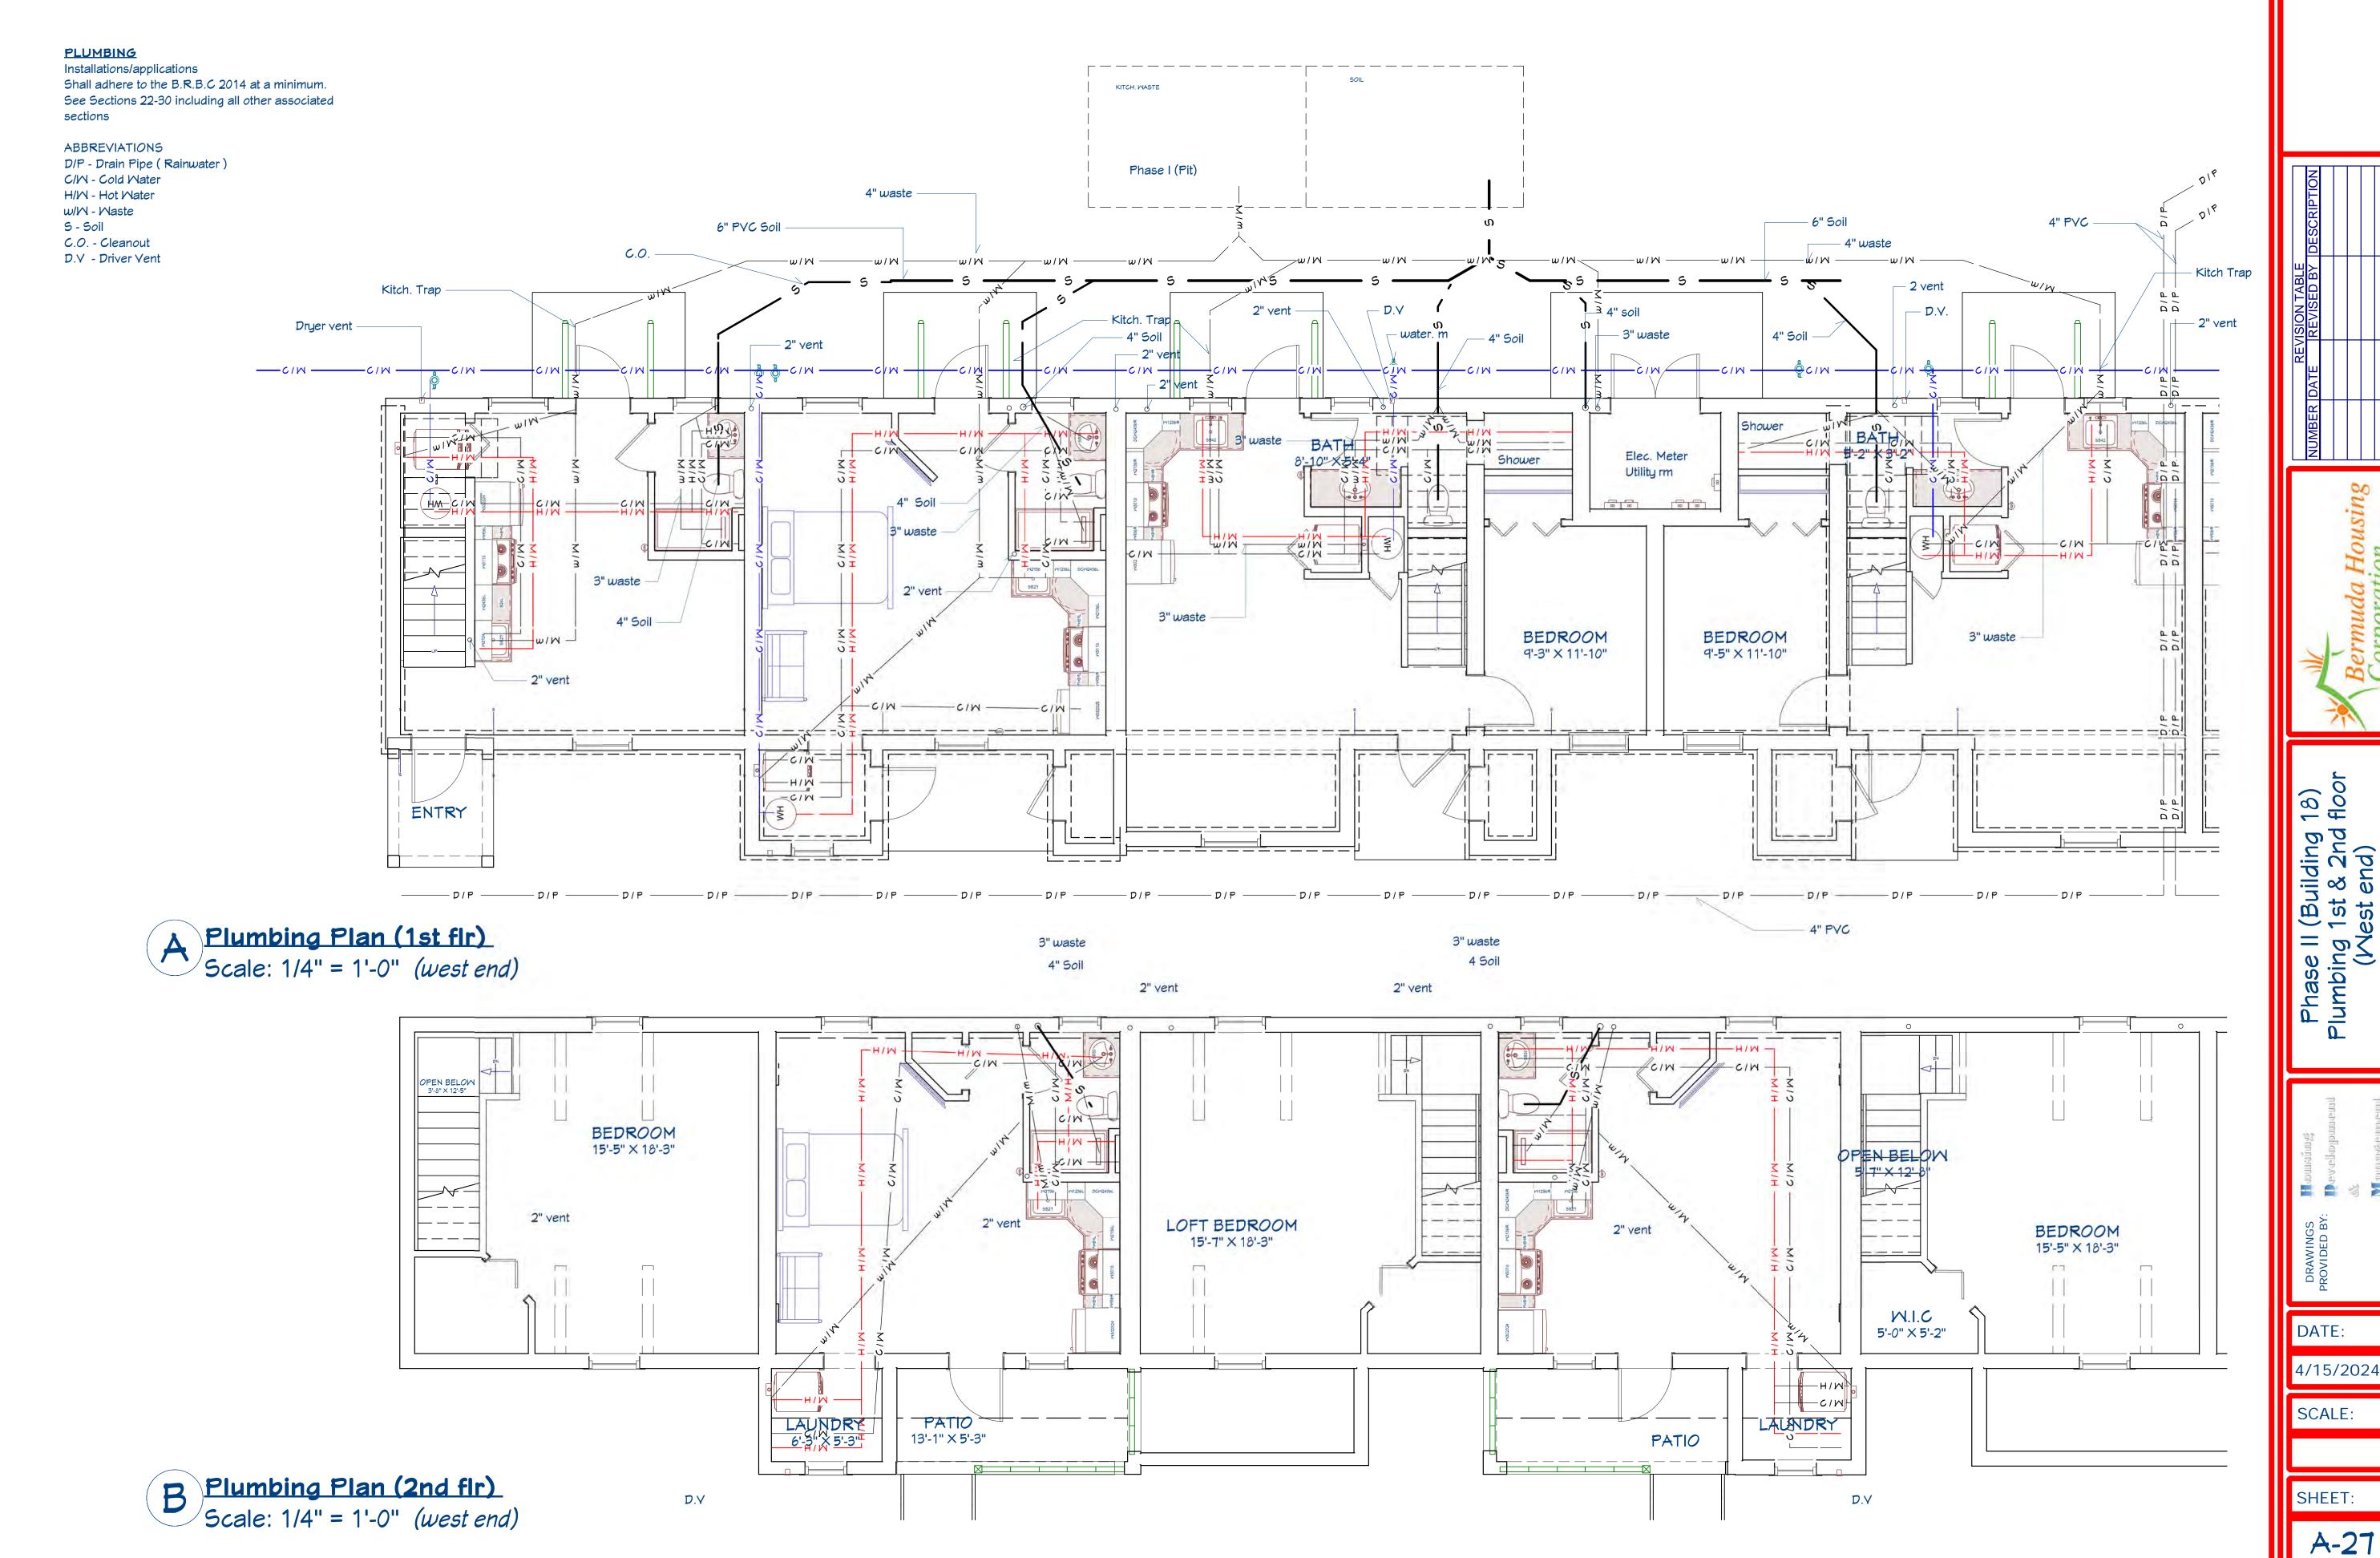


4/15/2024

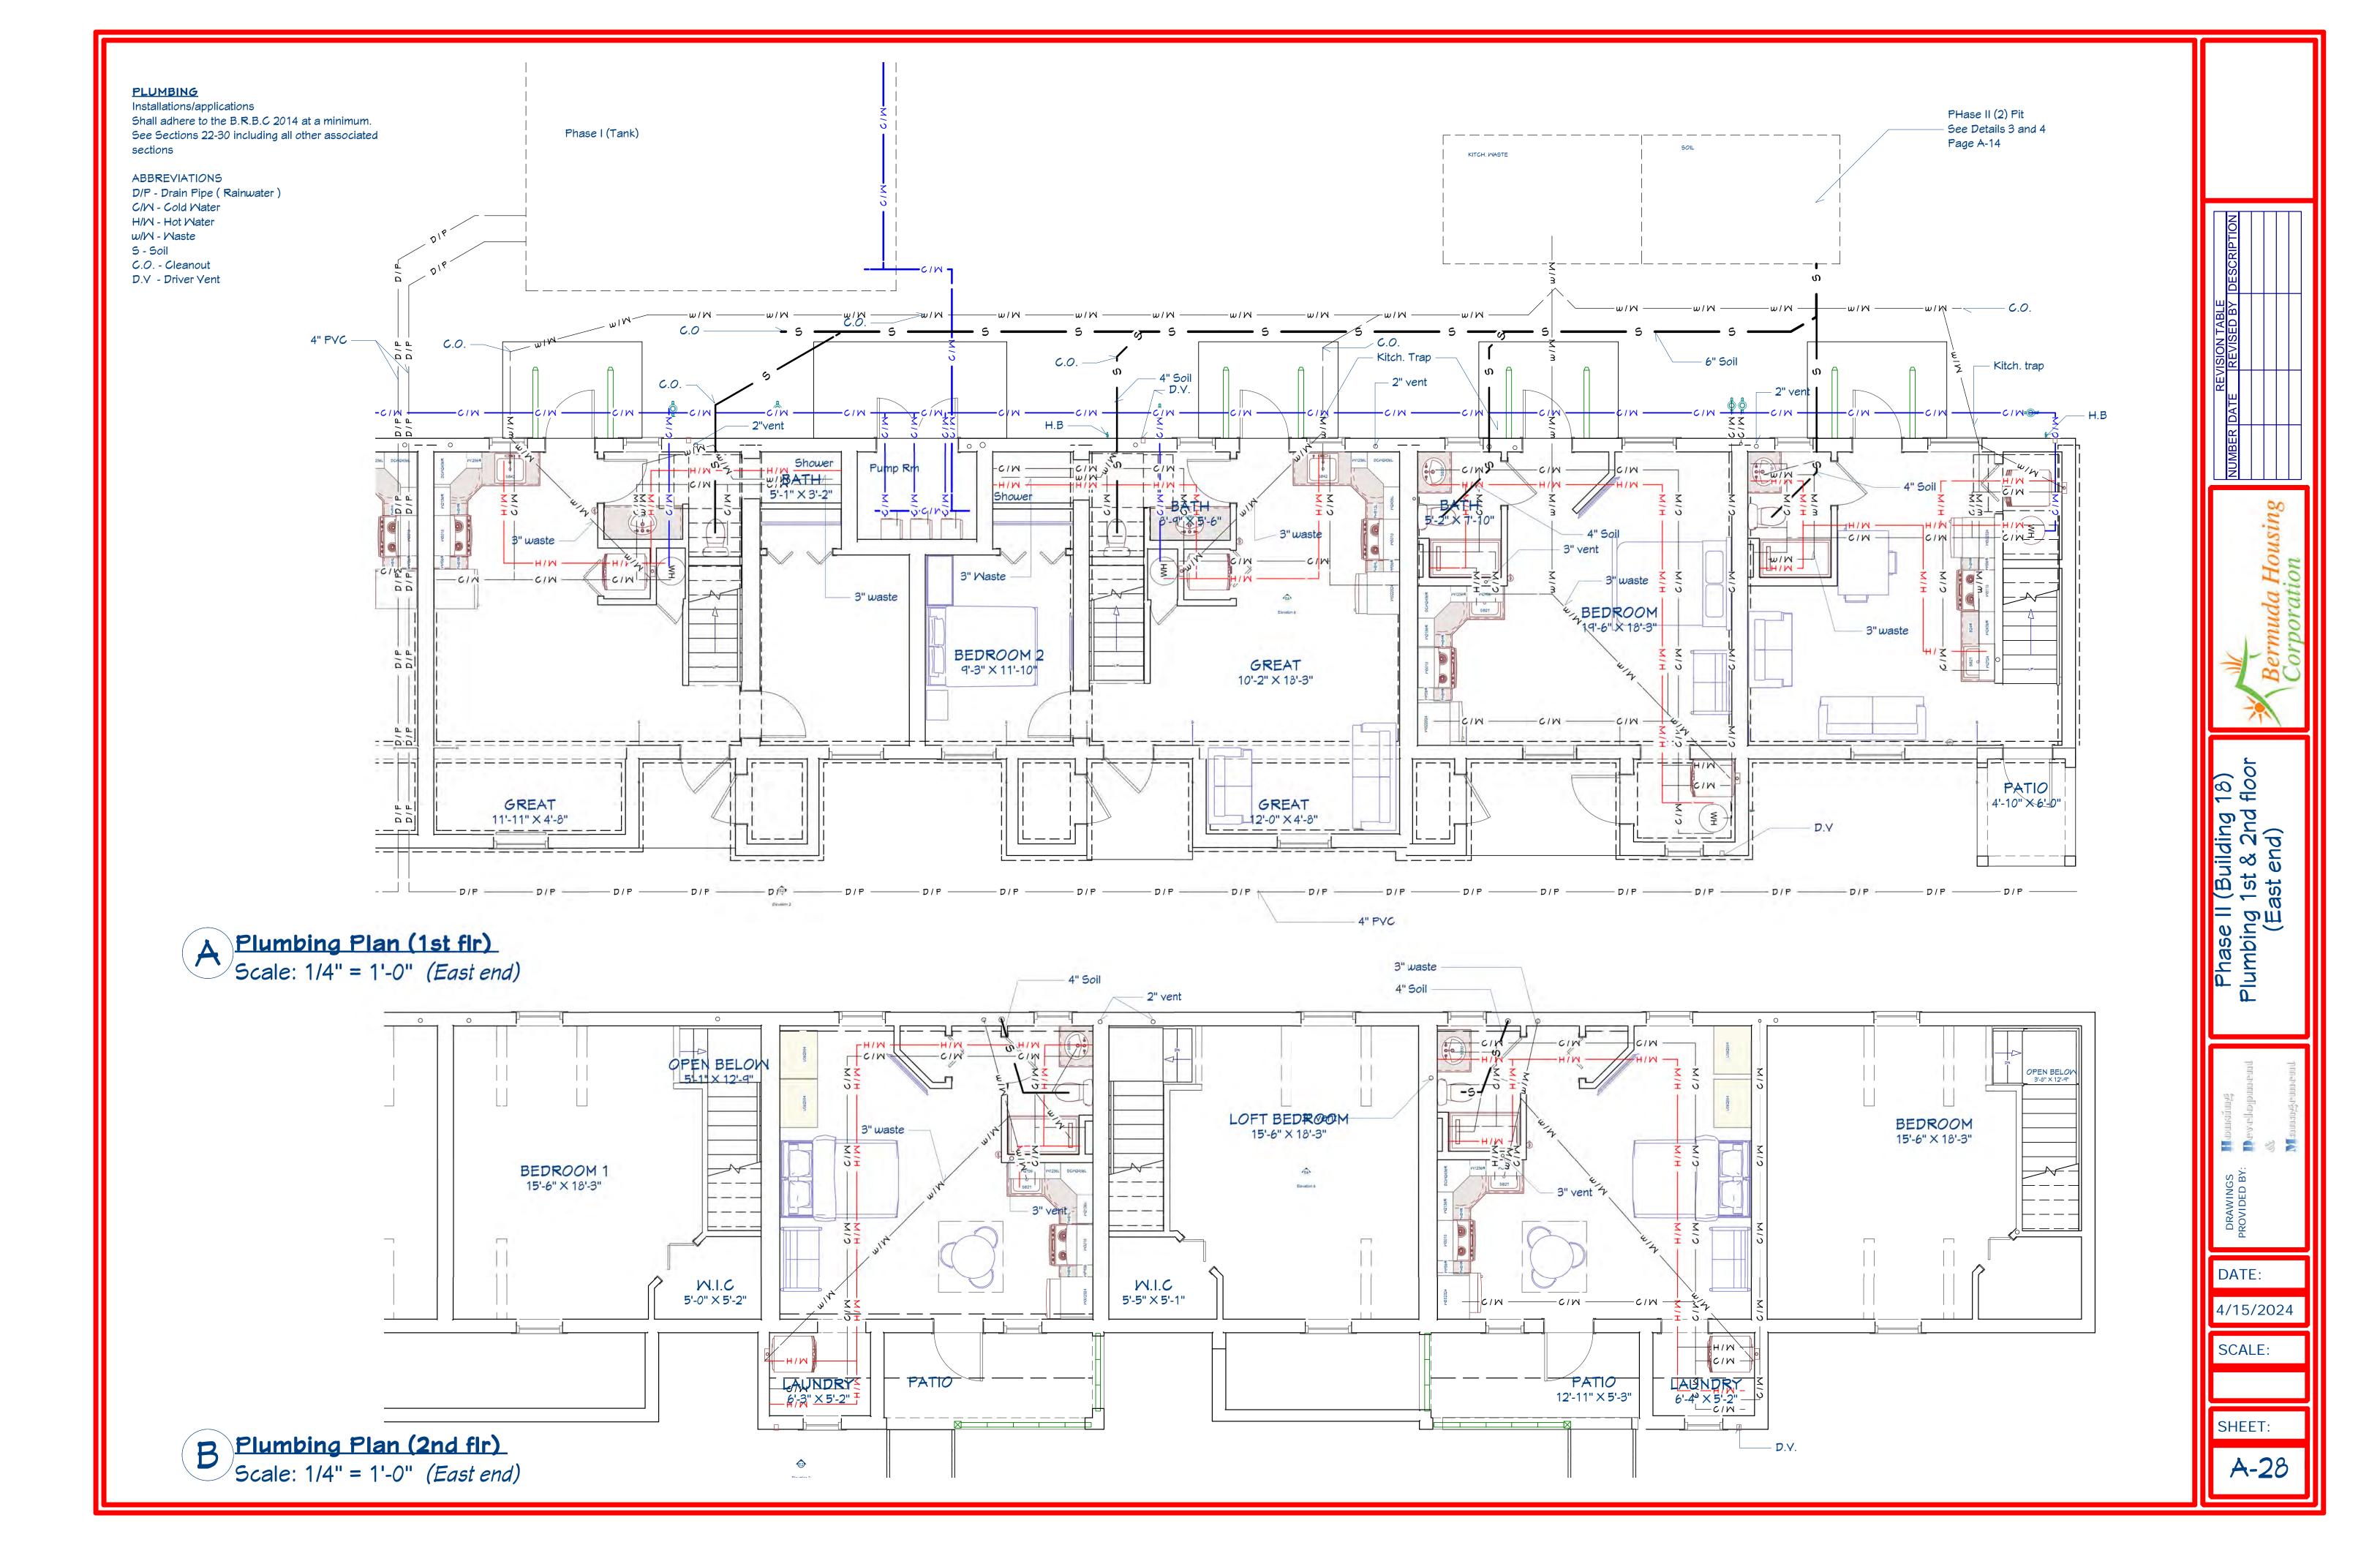

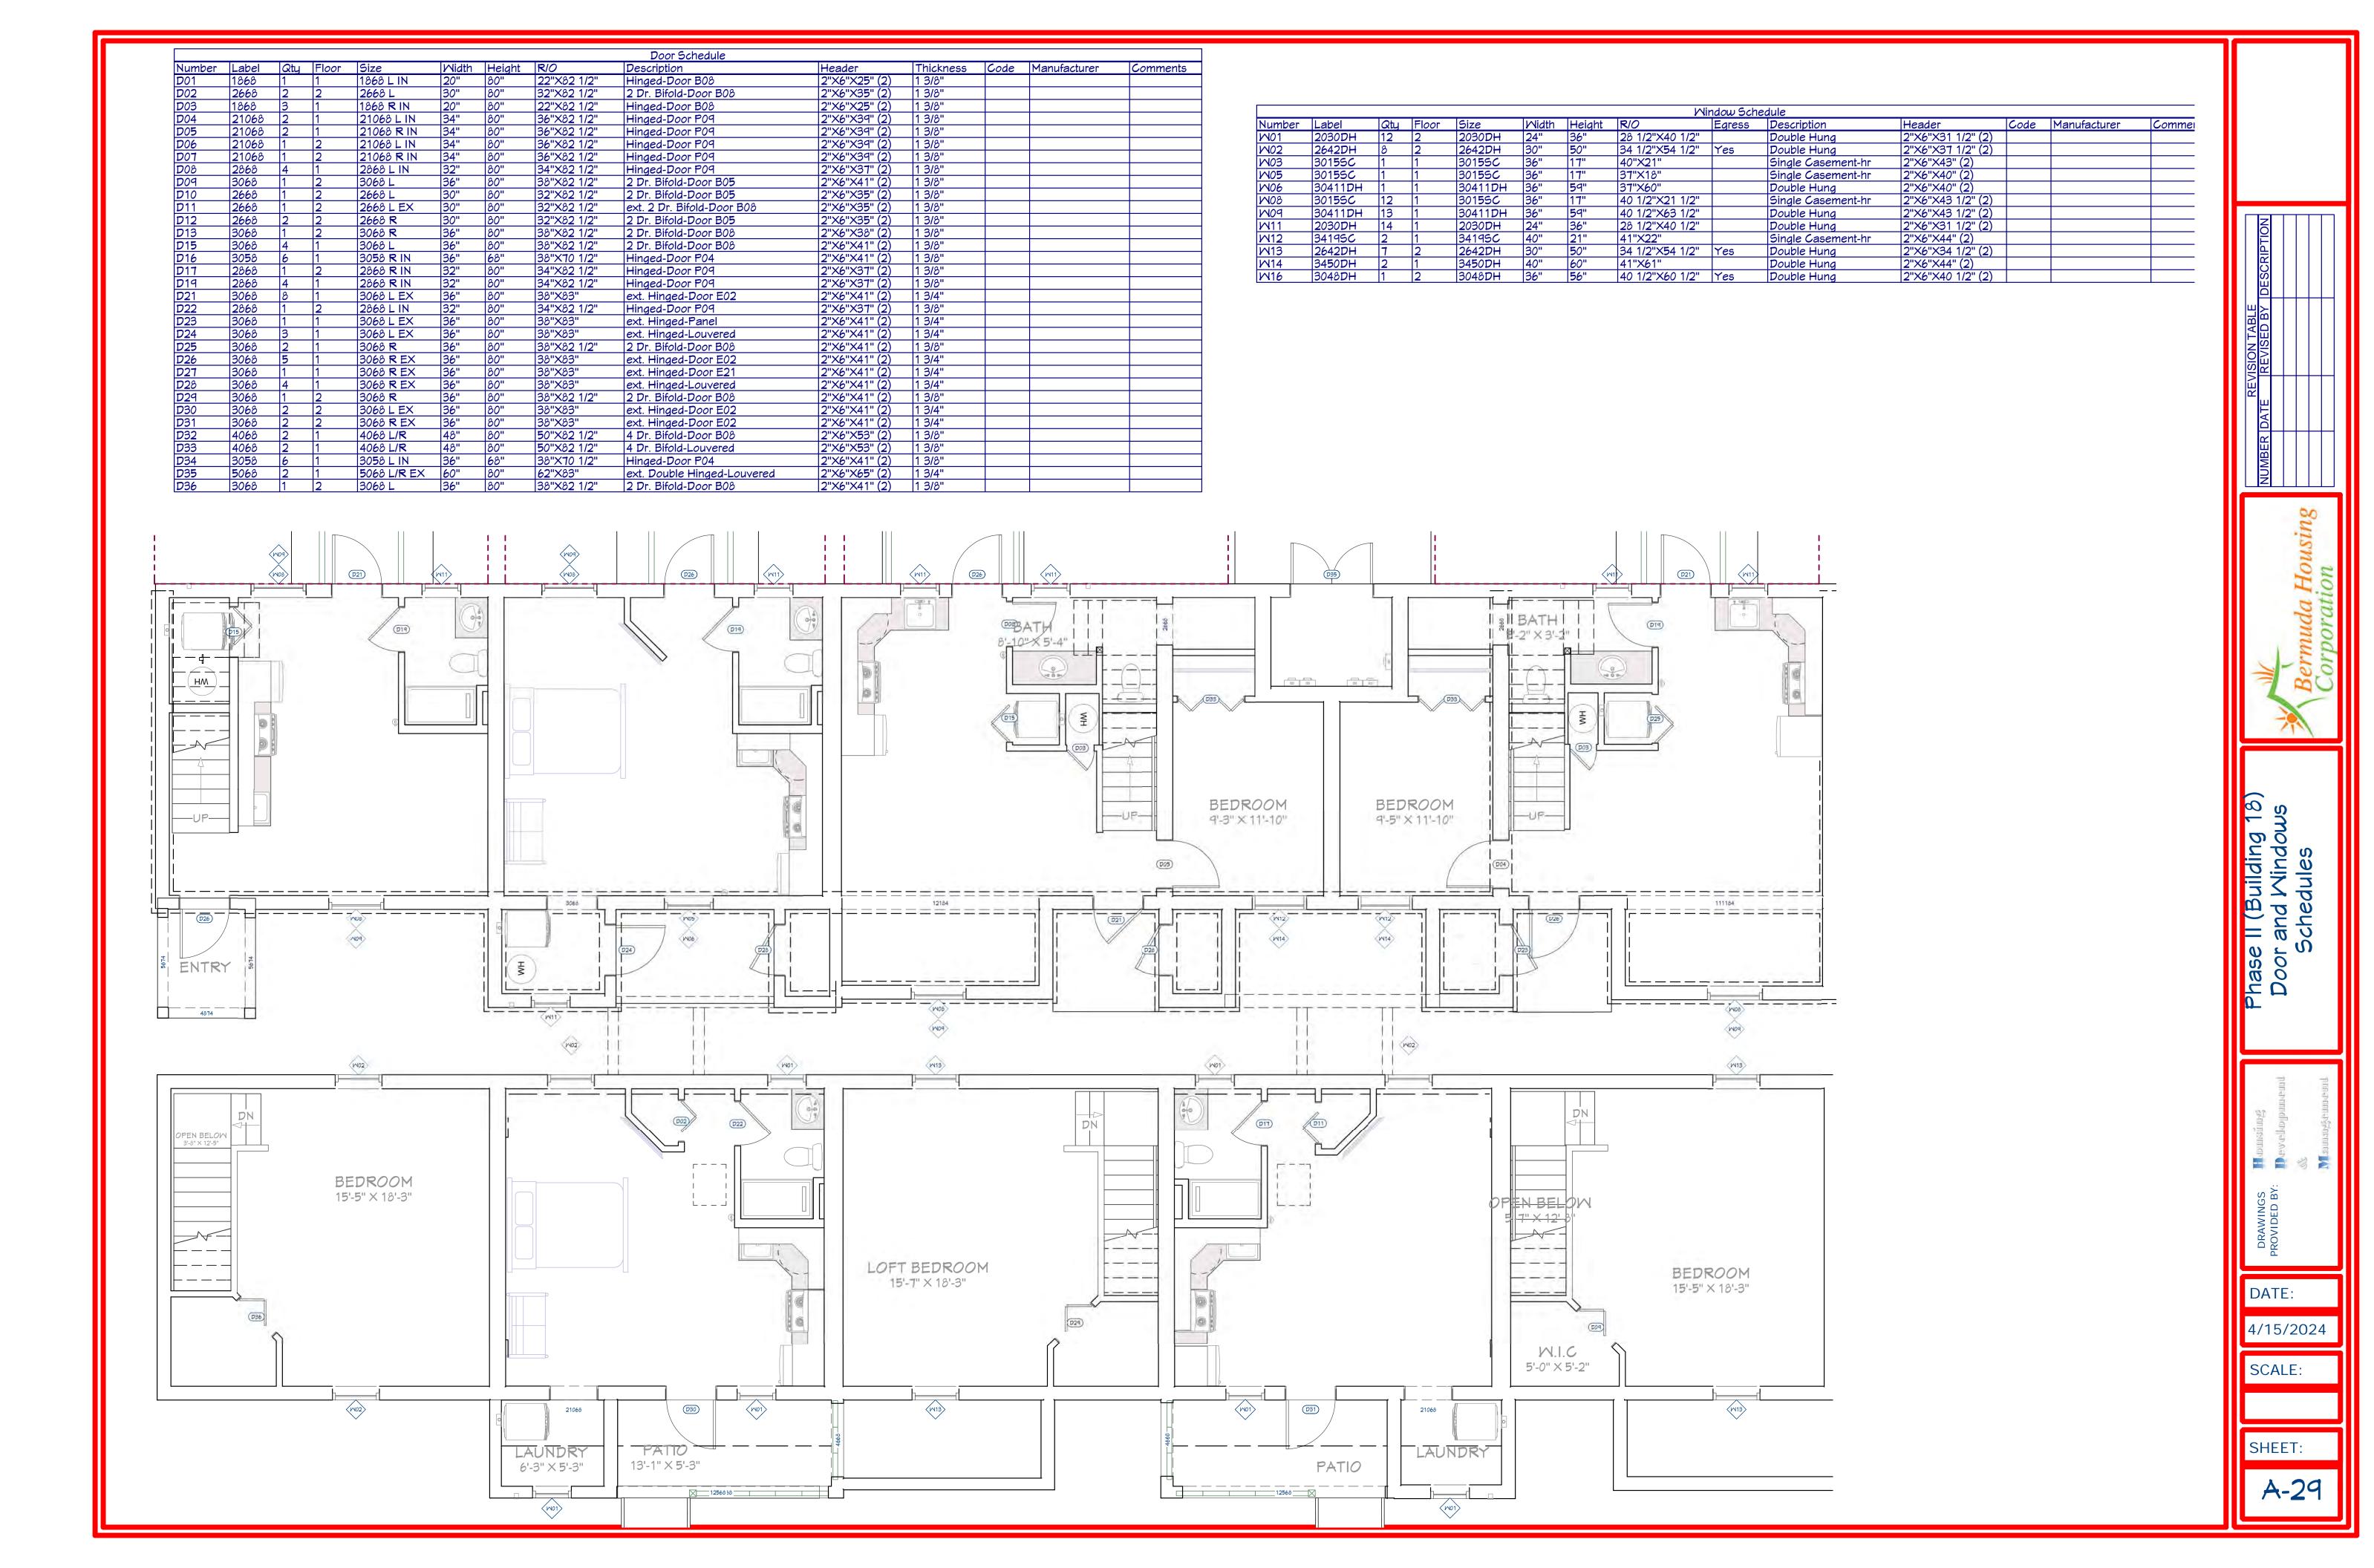

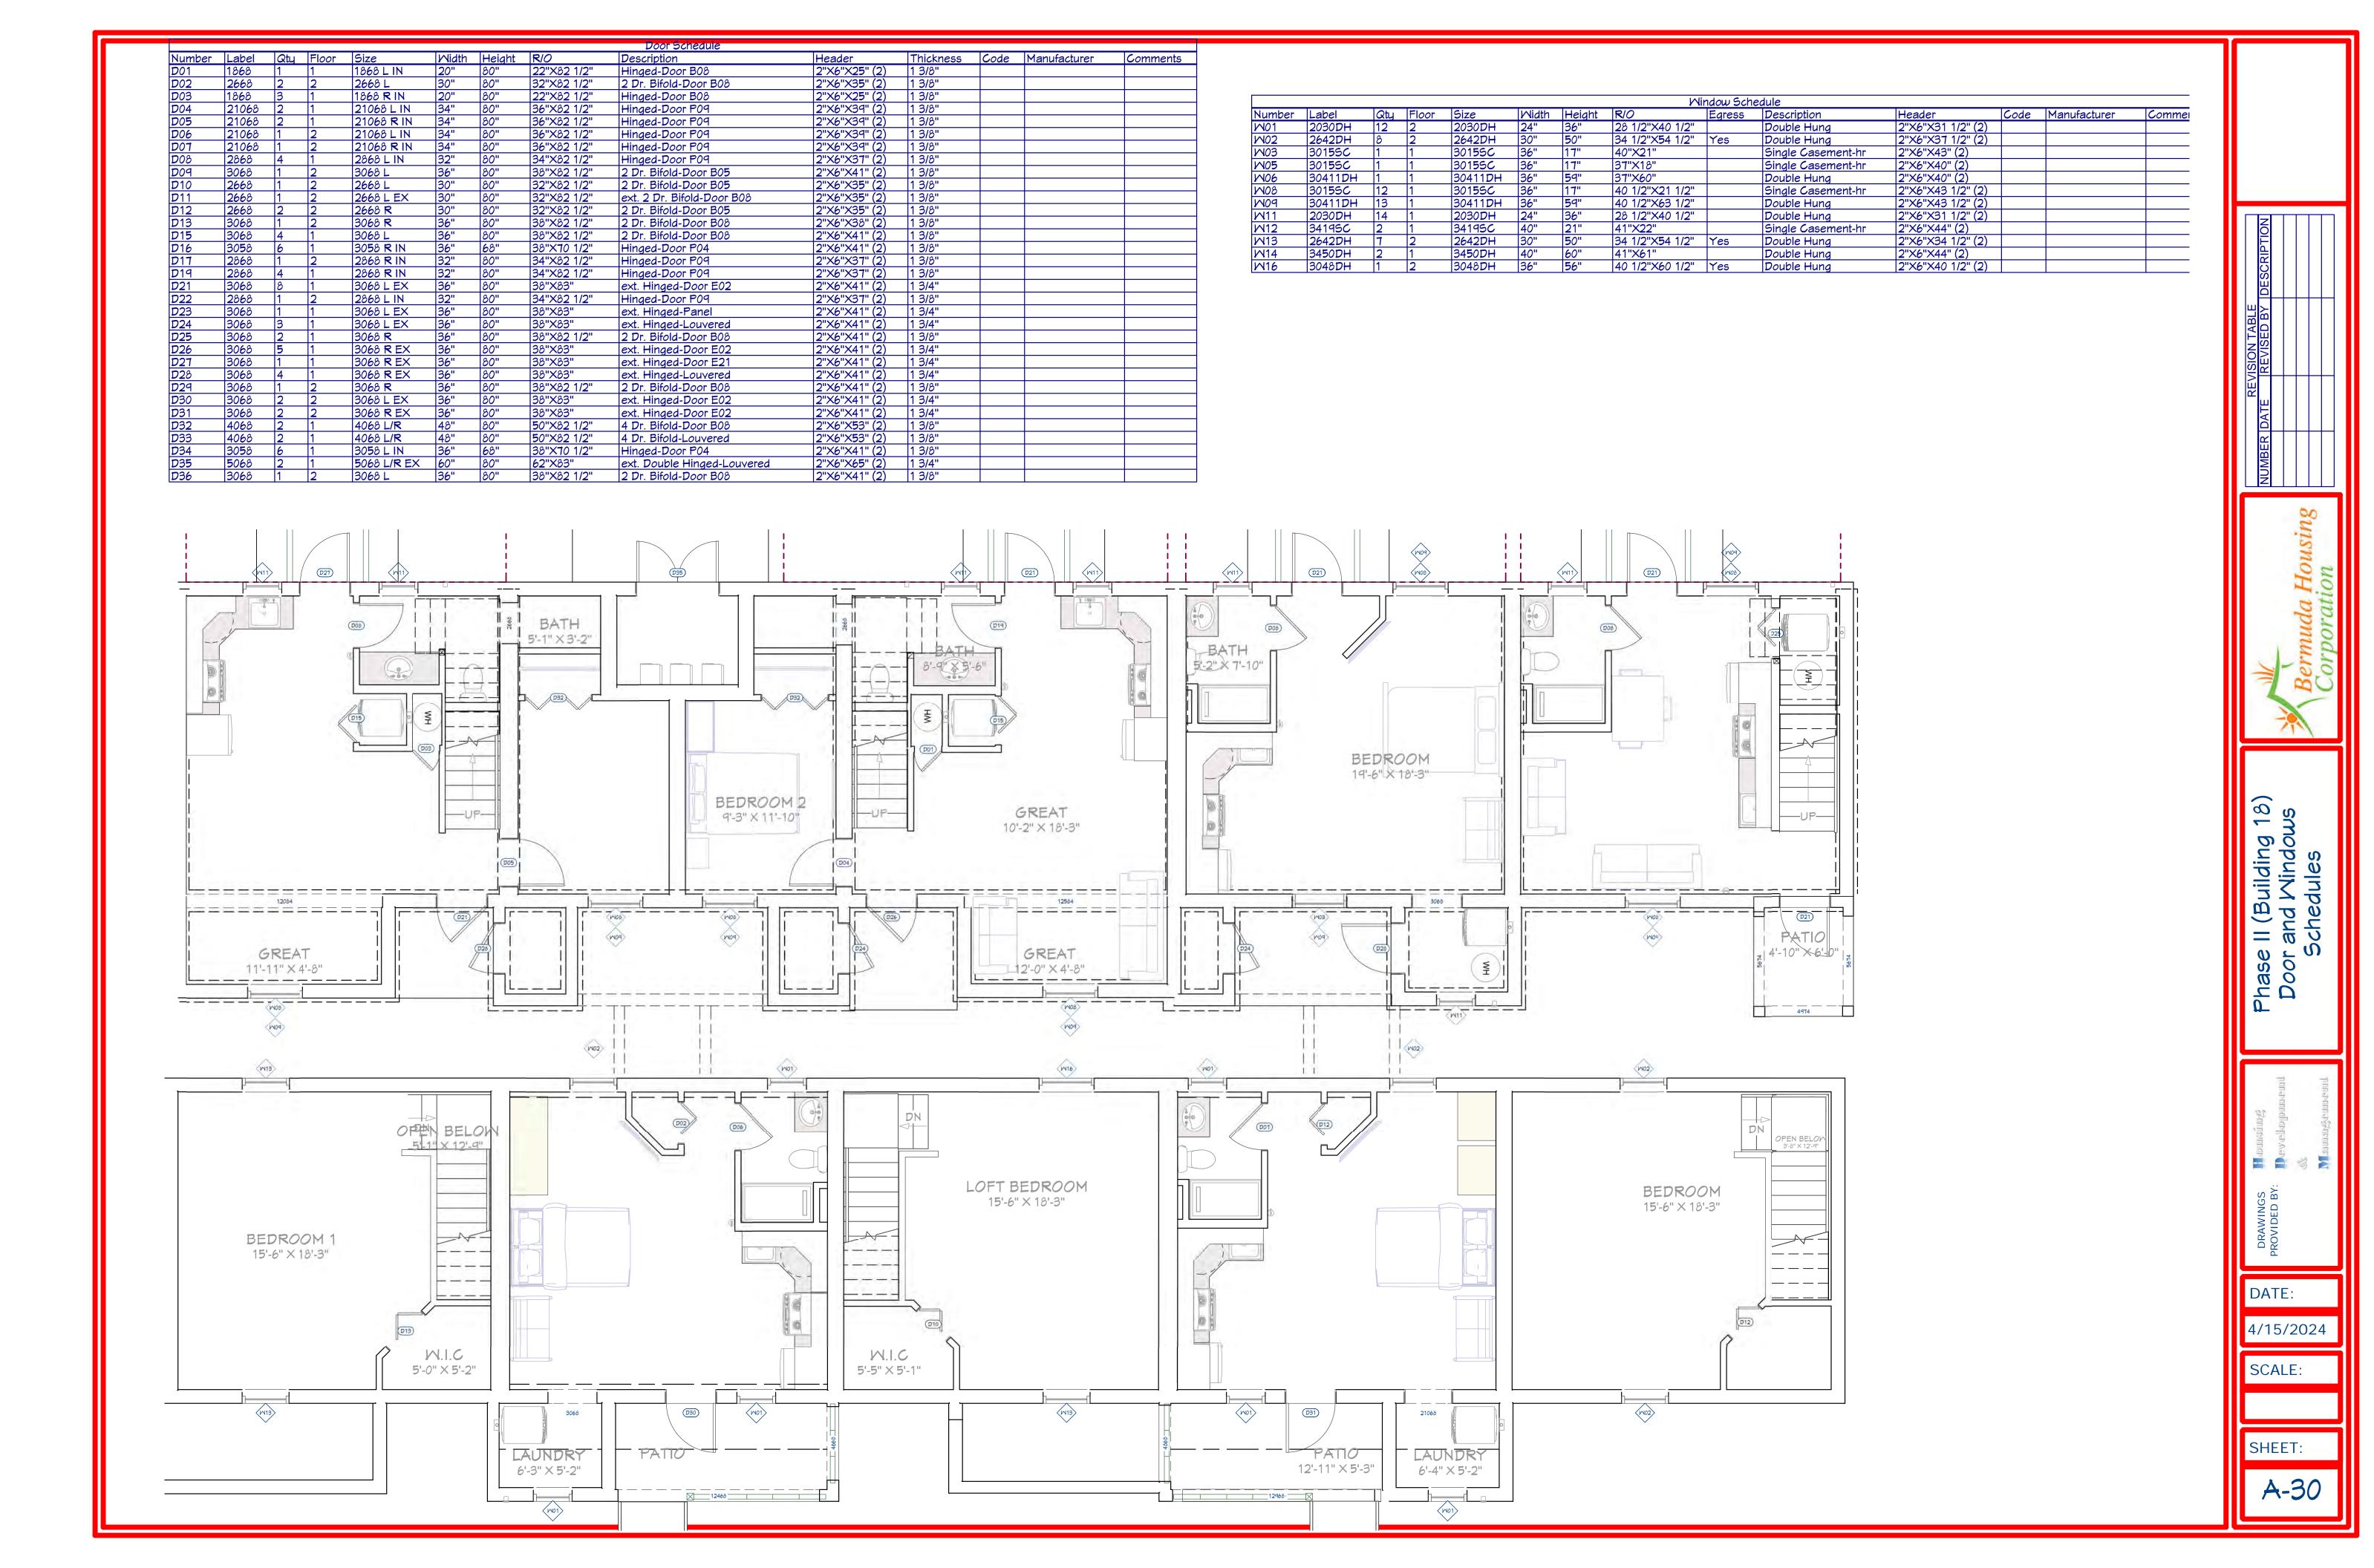

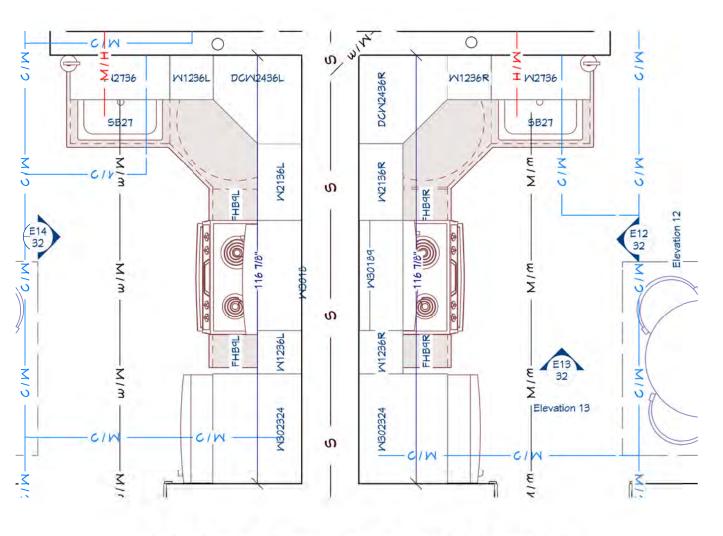

Kitchen Plan - Type1 (10+sqft)












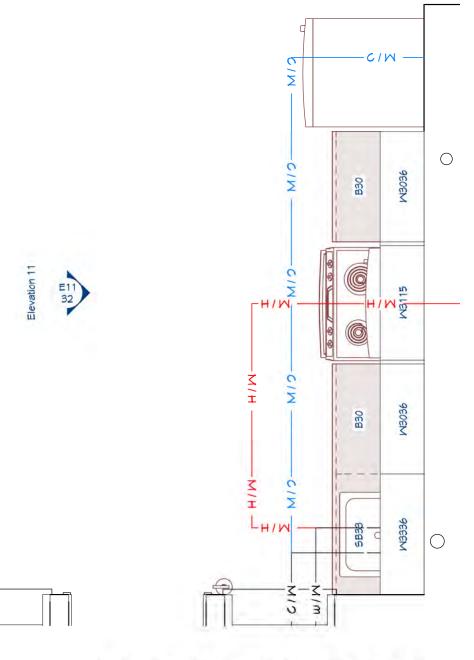

Kitchen Plan - Type 2 (10+sqft)



KITCHEN & CABINET NOTES:

- 1 ALL CABINETS FRAMELESS, MAPLE OR ALDER
- 2 CONFIRM FINISH & STAIN/PAINT WITH CLIENT PRIOR TO ORDERING
- 3 CONFIRM DOOR & DRAWER STYLES WITH CLIENT PRIOR TO ORDERING
- 4 INSTALL HARDWARE ON SITE
- 5 INSTALL CROWN MOLDING ON SITE; CONFIRM PROFILE AND DIMENSION WITH HOME OWNER
- 6 CABINET SUPPLIER RESPONSIBLE FOR FINAL MEASUREMENTS & CABINET OPENINGS FOR APPLIANCES SPECIFICATIONS
- 7 ALL APPLIANCES TO BE ON DEDICATED CIRCUITS, UNO. REFER TO APPLIANCE SPECIFICATIONS FOR AMP/ YOLTAGE REQUIREMENTS
- 8 USE MIN 6" DUCT FOR HOOD. CONFIRM HOOD IS 600 CFM MIN.
- 9 CONFIRM FINAL MATERIALS FOR BACKSPLASH AND COUNTERTOP WITH CLIENT PRIOR TO ORDERING 10 ALL DRAWERS TO BE TONGUE & GROOVE; GLIDES TO BE SOFT CLOSE
- 11 LED STRIP LIGHTS FOR WALL CABINETS AND UNDER ISLAND
- 12 UNDERCOUNTER GFCI ELECTRICAL PLUGS
- 13 COUNTER FABRICATION: CONFIRM ALL FIXTURE MEASUREMENTS AND CENTERLINES